FENCING & RETAINING WALL SCHEDU	JLE
TYPE OF FENCE HARDSCAPE MATERIAL	Length (A)
1800 High Painted Timber Paling Fence - LHS Return	441
	441 mm
1800 High Painted Timber Paling Gate - LHS Return	859
	859 mm
1800 High Treated Pine Timber Paling Fence - LHS	21,400
	21,400 mm
1800 High Treated Pine Timber Paling Fence - Rear	10,000
	10,000 mm
1800 High Treated Pine Timber Paling Fence - RHS	15,950
	15,950 mm
	48,650 mm

LANDSCAPING SCHEDULE				
Botanical Name/Common Name Size Qty. Plan				
Liriope Muscari/Liriope Evergreen Giant	Cover - 140mm	8	*	
Acmena Smithii/Allyn Magic	Shrub - 200	6		
Gardenia Augusta/Gardenia Florida	Shrub - 200mm	3		
Cordyline Australis/Cordyline Red Sensation	Shrub - 300mm	3		
Buckinghamia Celsissima/Ivory Curl Tree	Tree - 45lt	1	*	
		21		

# NOTE:


Fencing by others will not be removed or reinstated and is not the responsibility of the builder or builders warranty.

## NOTE:

Plant Selection at the Builders Discretion, May be Subject to Change due to Seasonal Availability

# NOTE:

All External Slabs to Finish 75mm Below DPC (Damp Proof Course)

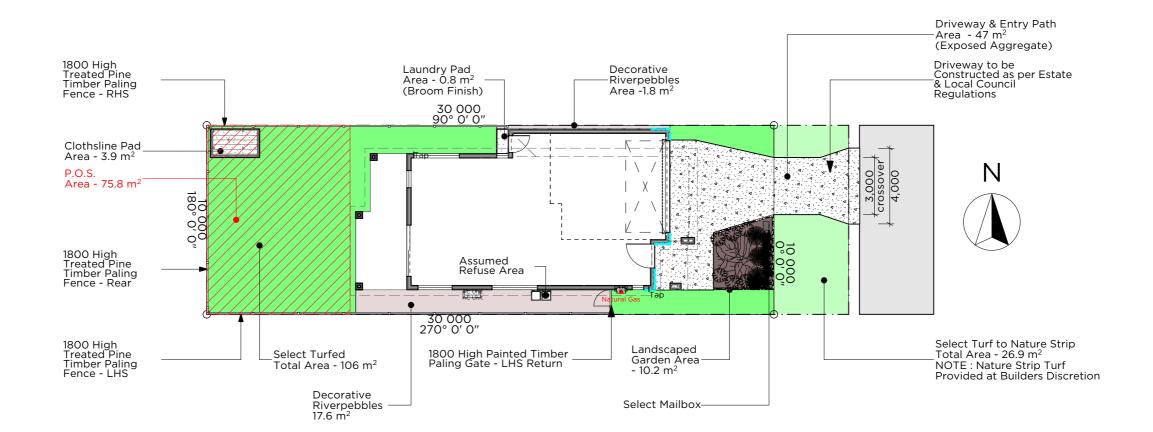



I/ WE APPROVE THESE DRAWINGS TO BE CORRECT AS PER CONTRACT	ARIZONA - Dimensions shall not be obtained by scaling. All dimensions are in millimeters unless noted otherwise.	client		scale: 1:200@A3
INITIAL	(Cantilever) - Setout dimensions shall be verified on site prior to any work being	project Lot TBA	project status: Contract Plans  soil class: BAL: TBA TBA	revision:
INITIAL	project number: carried out. Any problems shall be directed to the builder for clarification & correction REV.	DETAILS INT DATE local authority TBA	real property description: desc	date: 10:17 AM 05/03/2021

NOTES:
1. All building works to be completed in accordance with the N.C.C. 2016
2. Beams and supports to engineers' detail, and/or frame and truss manufacturers'


anid/or frame and truss manufacturers specification as required.


3. The tie down details to be as per the table on the bracing plan. Roof trusses to be as per the engineered design provided by the truss manufacturer, and fixed in accordance with their details.

their details.

4. Roof members, trusses, floor joists and prefab frames designed and installed to manufacturers specifications.

5. 450mm eave unless notified otherwise.

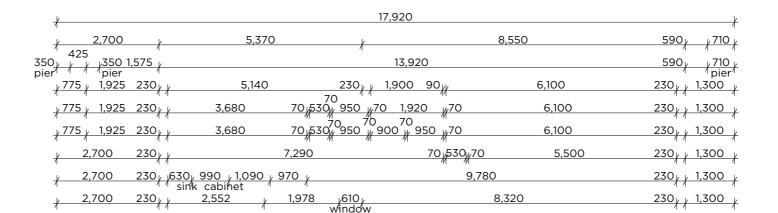


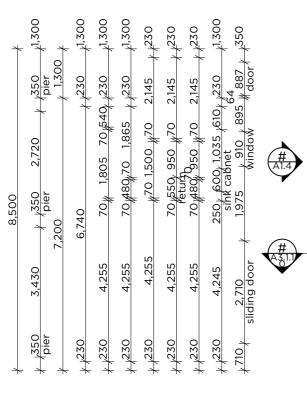

Floor Plan - Lower

Plan

SCALE: 1:100

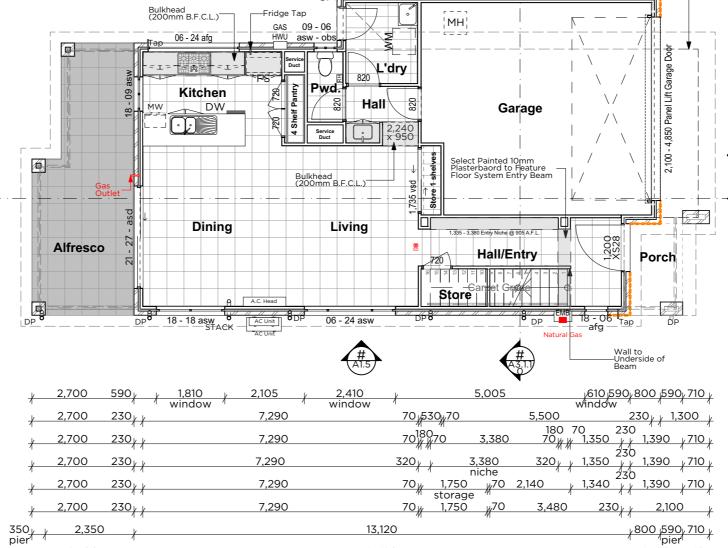

13,120 17,920

	TOTAL AREAS			
1	Living Lower	73.28		
2	Living Upper	102.65		
3	Garage	36.12		
4	Alfresco	17.06		
5	Porch	4.42		
6	Stair Void	10.35		
		243.88 m		

+ \<sup>230</sup> \* \pm 230

<sub>4</sub>230

5,620

1230

2,420

2,070

350 pier

2,420

6,080

8,500

, 1230

5,620 5,620 5,620

7023070

2,580

4230

615

4,850 garage door

1,153 , 1,267 ,615

70<sub>#</sub> 1,280 <sub>#</sub>70 980 300,70

1,230 1,230

70% 2,280

6. Glazing to comply with AS1288 and AS2047.

AS2047.
7. Smoke alarms to comply with AS3786.
8. Concrete construction as per Engineers Design, and to comply with AS2870 -2011 and AS3600.
9. Brickwork to comply with AS2870 and AS3700, Articulation joints to be installed as per the engineers drawings. R3 brick ties to be used and R4 brick ties must be used where the residence is within 1km of the ocean.
10. 10mm plaster direct fix to walls and ceilings, 6mm villaboard fixed to wet area walls.
11. Structural Steel as per engineers design.

walls.
11. Structural Steel as per engineers design.
12. Tiling to comply with AS3958.
13. Roofing to be installed in accordance with AS2049-2050, and AS1562.1
14. Waterproofing to comply with AS3740

and AS4654.

15. Termite Management System to be installed in accordance with AS3600.1-2000.

I/ WE APPROVE THESE DRAWINGS TO BE CORRECT AS PER CONTRACT
INITIAL
INITIAL

ARIZONA -
245 - Drake
(Cantilever) -
project number:
Standard Plan

2,700 alfresco

DETAILS	INT	D/

	client I		ng name: or Plan - Lo	wer	Ν
	project Lot TBA	project status: Contract Plans			
DATE	local authority TBA	cov:	Small Lot Code	drawn: TDA	check: JDA

1,390 710 porch pier

Line of Upper

Floor System

	wind class:	flood level:
Ν	TBA	TBA
	soil class:	BAL:
$\left( \mathbf{A} \right)$	TBA	TBA
<b>V</b>	real proper	ty descriptio
	TDA	

wind class:	flood level:	scale:	
TBA	TBA	1:100@A3	
soil class:	BAL:	revision:	
TBA	TBA		
real property description:			
TBA		05/03/2021	


NOTES:
1. All building works to be completed in accordance with the N.C.C. 2016
2. Beams and supports to engineers' detail, and/or frame and truss manufacturers'


- anid/or frame and truss manufacturers specification as required.

  3. The tie down details to be as per the table on the bracing plan. Roof trusses to be as per the engineered design provided by the truss manufacturer, and fixed in accordance with their details.
- their details.

  4. Roof members, trusses, floor joists and prefab frames designed and installed to manufacturers specifications.

  5. 450mm eave unless notified otherwise.

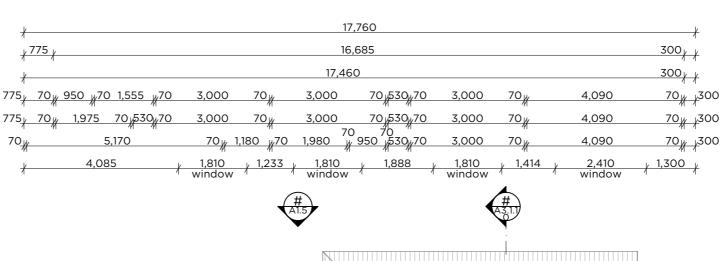

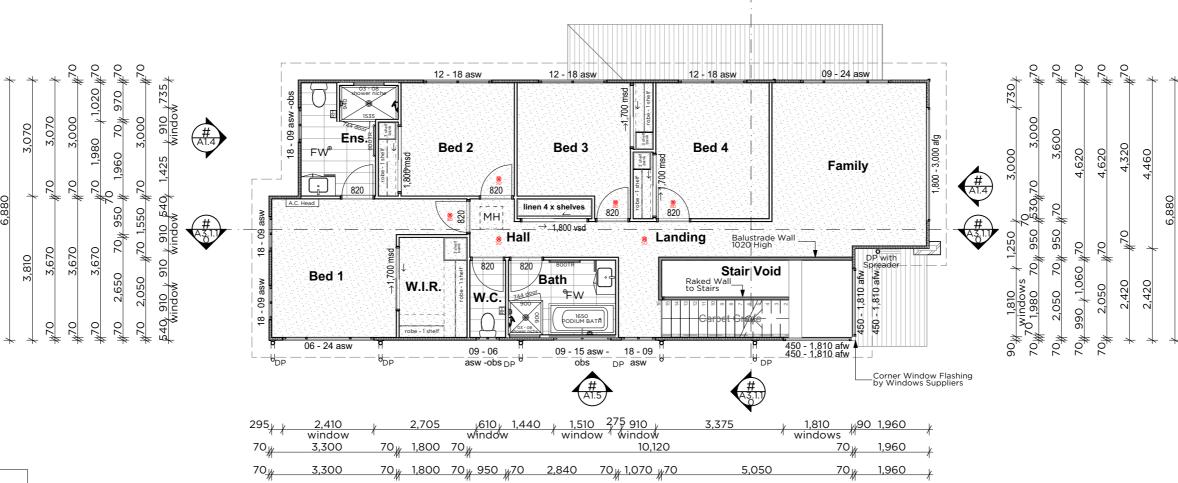

N	ОΤ	ES
16	CI	27

6. Glazing to comply with AS1288 and AS2047.


6. Glazing to comply with AS1288 and AS2047.
7. Smoke alarms to comply with AS3786.
8. Concrete construction as per Engineers Design, and to comply with AS2870 -2011 and AS3600.
9. Brickwork to comply with AS2870 and AS3700, Articulation joints to be installed as per the engineers drawings. R3 brick ties to be used and R4 brick ties must be used where the residence is within 1km of the ocean.
10. 10mm plaster direct fix to walls and ceilings, 6mm villaboard fixed to wet area walls.
11. Structural Steel as per engineers design.
12. Tiling to comply with AS3958.
13. Roofing to be installed in accordance with AS2049-2050, and AS1562.1
14. Waterproofing to comply with AS3740 and AS4654.
15. Termite Management System to be installed in accordance with AS3600.1-2000.

			7	<del>41.5</del>	A31.1			
295	2,410 window		610 1,440 1,51 ndow wind		3,375	1,810 y90 windows	1,960	+
70 <sub>#</sub>	3,300	70 <sub>//</sub> 1,800 70 <sub>//</sub>		10,120		70	1,960	+
70 <sub>//</sub>	3,300	41 41	70 2,840	70 / 1,070 / 70	5,050	70 <sub>//</sub>	1,960	+
70_#	3,300	70 <sub>//</sub> 1,800 70 <sub>//</sub> 9	950 <sup>70</sup> 1,070 / 1,77	<u>70</u>	6,190	70 <sub>//</sub>	1,960	+
70_#	3,300	70 1,800 70 9	70 2,840	<sub>#</sub> 70	6,190	70 <sub>//</sub>	1,960	+
*			1′	7,460				+


Plan			
Floor SCALE:	Plan 1:100	- (	Jpper

	TOTAL AREAS						
1	Living Lower	73.28					
2	Living Upper	102.65					
3	Garage	36.12					
4	Alfresco	17.06					
5	Porch	4.42					
6	Stair Void	10.35					
		243.88 m					

								•	
I/ WE APPROVE THESE DRAWINGS TO BE CORRECT AS PER CONTRACT	ARIZONĄ -   1	Dimensions shall not be obtained by			client	drawing name:			scale:
CORRECT AS PER CONTRACT	245 - Drake	millimeters unless noted otherwise.			I .	_ Floor Plan - Upper	N L	BA TBA	1:100@A3
INITIAL	(Cantilever) -	Setout dimensions shall be verified on site prior to any work being			project	project status:	/ A \		revision:
		carried out. Any problems shall be			Lot TBA	Contract Plans		BA TBA	
INITIAL		directed to the builder for clarification & correction				Contract Haris	re	eal property description	n: date: 10:17 AM
	Standard Plan	REV.	DETAILS	INT DATE	local authority TBA	cov: Small Lot Code drawn: TDA ched	ck: JDA T	BA	05/03/2021

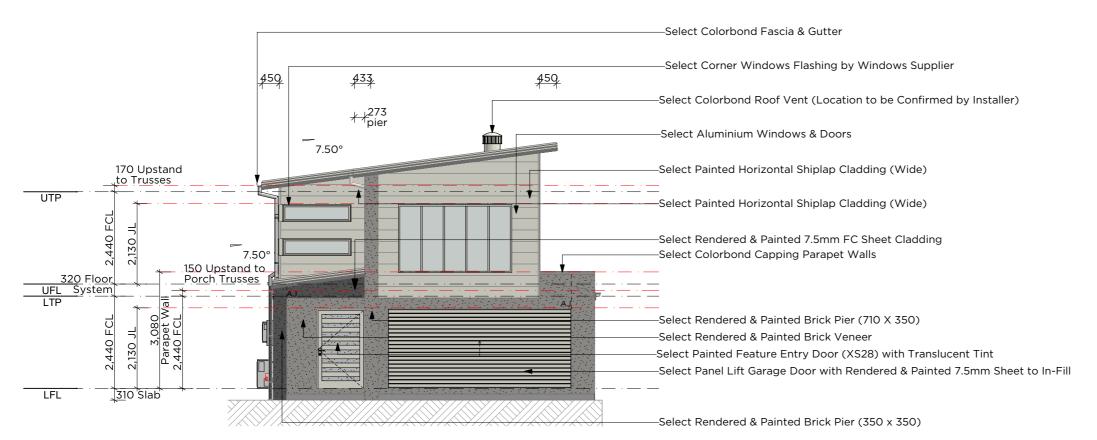




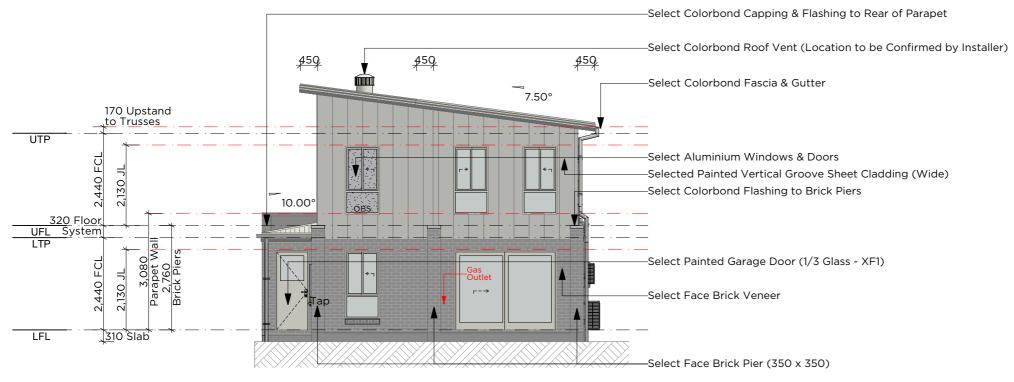


Elevation Rear SCALE: 1:100

ALL DESIGN CONSTRUCTION & MATERIALS TO BE IN ACCORDANCE WITH:
THE NATIONAL CONSTRUCTION CODE (NCC);
THE BUILDING CODE OF AUSTRALIA (BCA);
THE QUEENSLAND DEVELOPMENT CODE (QDC);
BUILDING REGULATIONS & LOCAL GOVERNMENT PLANS & POLICIES CURRENT ISSUES OF AUSTRALIAN STANDARDS CURRENT MANUFACTURERS SPECIFICATIONS & INSTALLATION DETAILS FOR MATERIALS USED

I/ WE APPROVE THESE DRAWINGS TO BE CORRECT AS PER CONTRACT	ARIZONA - 245 - Drake	Dimensions shall not be obtained by scaling. All dimensions are in millimeters unless noted otherwise.					client	drawing name: Elevations 1 of	2 N	wind class: flood level: TBA TBA	1:100@A3
INITIAL	(Cantilever) -	Setout dimensions shall be verified on site prior to any work being carried out. Any problems shall be					project Lot TBA	project status: Contract Plans		soil class: BAL: TBA TBA	revision:
INITIAL	project number: Standard Plan	directed to the builder for clarification & correction	REV.	DETAILS	INT	DATE	local authority TBA		drawn: TDA check: JDA		n: date: 10:17 AM 05/03/2021

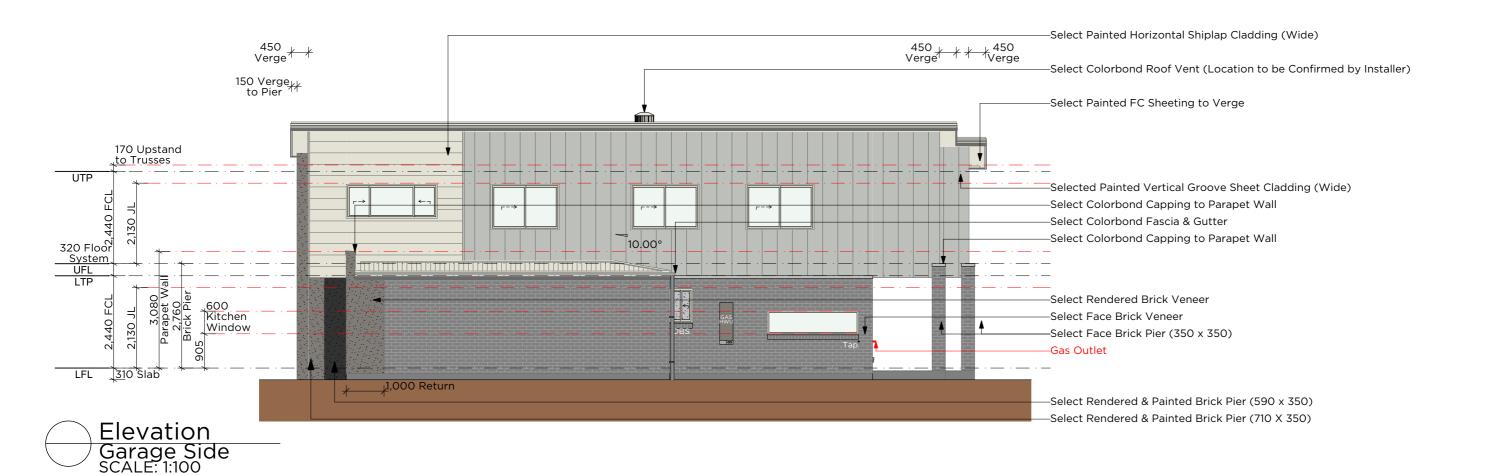

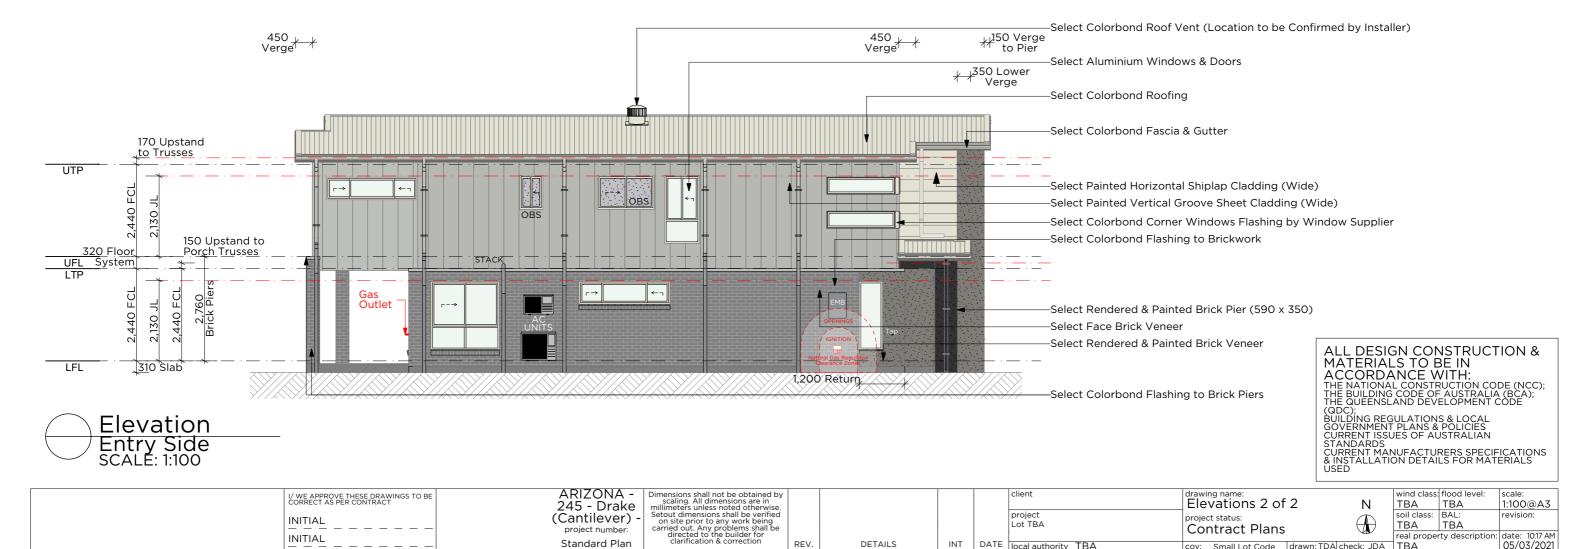

DETAILS

(Cantilever)

Standard Plan

INITIAL

INITIAL

project Lot TBA

INT DATE local authority TBA

project status:

Contract Plans

soil class: BAL: TBA

cov: Small Lot Code | drawn: TDA| check: JDA | TBA

revision:

date: 10:17 AM 05/03/2021

#### **ELECTRICAL SCHEDULE** 2-WAY 2 Way Switch 3 in 1 Light Combo (Heat, Fan, Light) - Externally Ducted 2 Bunker Light - Wall Mount Ceiling Fan DATA Outlet Electrical Meter Box EXT - 2 External GPO Double - 1000H - Alfresco EXT External GPO Single - 1000H - Hot Water System 2-AB GPO Double - 1050H 2-W GPO Double - 1800H GPO Double - 300H 10 GPO Double with USB - 300H 2-AB USB GPO Double with USB-1050H REF. GPO Single - 1800H GPO Single - 1800H - Rangehood GPO Single - Ceiling Mounted - Panel Lift Door GPO Single - Under Bench - Dishwasher GPO Single - Under Bench - Microwave Oven GPO Single - Under Bench - Under Bench Oven 30 ĒΩ LED Downlight LED Osyter Light - Surface Mount NBN-W NBN Service Connection - 1800H Phone Point Phone Point - 1050H 7 Smoke Alarm TV Outlet 3

El	ELECTRICAL APPLIANCE LEGEND					
[-F-]	Fridge Space Only - Owner to Supply	1				
	Haier 2.5kW Indoor A.C. Unit	1				
	Haier 2.5kW Outdoor A.C. Unit	1				
	Haier 7.0kW Indoor A.C. Unit	1				
	Haier 7.0kW Outdoor A.C. Unit	1				
	IAG 600mm Dishwasher - GDS14	1				
( n	IAG 900mm Gas Cooktop - ICD9SG6	1				
	IAG 900mm Oven - IOM9SE4	1				
	IAG 900mm Slideout Randehood - RS9S - Externally Ducted	1				
	RINNIA Infinity 20 Litre Continuous Gas Hot Water System	1				
PM1	Washing Machine Space Only - Owner to Supply	1				
		11				

# ALL DESIGN CONSTRUCTION & MATERIALS TO BE IN ACCORDANCE

MATERIALS TO BE IN ACCORDANCE WITH:
THE NATIONAL CONSTRUCTION CODE (NCC); THE BUILDING CODE OF AUSTRALIA (BCA); THE QUEENSLAND DEVELOPMENT CODE (QDC); BUILDING REGULATIONS & LOCAL GOVERNMENT PLANS & POLICIES CURRENT ISSUES OF AUSTRALIAN STANDARDS CURRENT MANUFACTURERS SPECIFICATIONS & INSTALLATION DETAILS FOR MATERIALS USED

#### **ELECTRICAL NOTES:**

84

- All Electrical work carried out to comply with AS3000 - 2007
- All external power points to be weather-proof - All Electrical points T.B.C on site by client and electrician - PROVIDE 80% min. ENERGY EFFICIENT LIGHTING as per QDC guidelines.

# NOTE:

SMOKE ALARMS TO COMPLY WITH THE BUILDING REGULATIONS 06 PART 3A, FIRE & EMERGENCY SERVICES BILL 2016 & NCC




#### NOTE:


EXHAUST FANS TO BE EXTERNALLY DUCTED AS PER N.C.C. REGULATIONS

### NOTE:

Section 3.12.3.3 An external door, internal door or between a class 1 & unconditioned class 10 shall have seal installed to the bottom of the door; and form or rubber edges to the other sides or edges

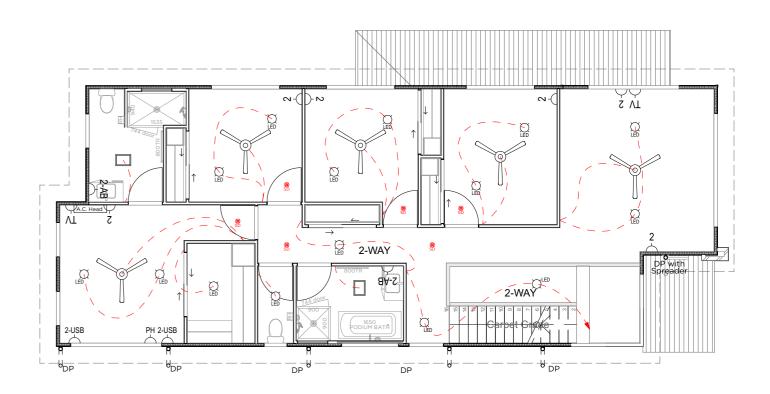




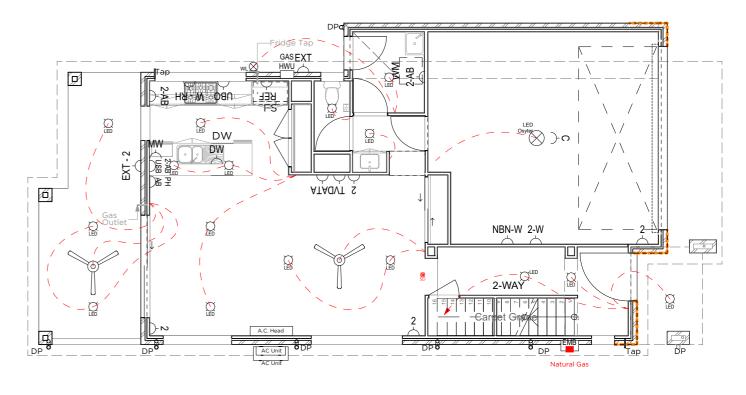




I/ WE APPROVE THESE DRAWINGS TO BE	ARIZONA - Dimensions shall not be obtained by	client drawing name: wind class: flood le	vel: scale:
CORRECT AS PER CONTRACT	245 - Drake scaling. All dimensions are in millimeters unless noted otherwise.		1:100@A3
		project poil place. DAL	revision:
INITIAL	(Cantilever) - Setout dimensions shall be verified on site prior to any work being	project status.	Tevision.
	project number:   carried out. Any problems shall be	Contract Plans TBA TBA	
NITIAL	directed to the builder for	real property description	ription: date: 10:18 AM
	Standard Plan   clarification & correction   REV.   DETAILS	INT DATE local authority TBA cov: Small Lot Code drawn: TDA check: JDA TBA	05/03/2021

FINISH FLOOR MATERIAL SCHEDULE						
FLOOR TYPE	ROOM	AREA				
Carpet	Bed 1	13.71				
Carpet	Bed 1 - W.I.R.	4.67				
Carpet	Bed 2	8.88				
Carpet	Bed 2 - robe	0.98				
Carpet	Bed 3	9.44				
Carpet	Bed 3 - robe	0.89				
Carpet	Bed 4	10.67				
Carpet	Bed 4 - robe	0.88				
Carpet	Linen	1.00				
Carpet	Living - Upper	27.55				
		78.67 m				
External Tile	Alfresco	16.74				
		16.74 m				
Main Floor Tile	Laundry	4.00				
Main Floor Tile	Living - Lower	48.18				
Main Floor Tile	Store	0.93				
		53.11 m				
Wet Area Floor Tile	Bathroom	4.44				
Wet Area Floor Tile	Ensuite	6.20				
Wet Area Floor Tile	Powder	1.72				
Wet Area Floor Tile	W.C.	1.90				
		14.26 m				
		162.78 m				

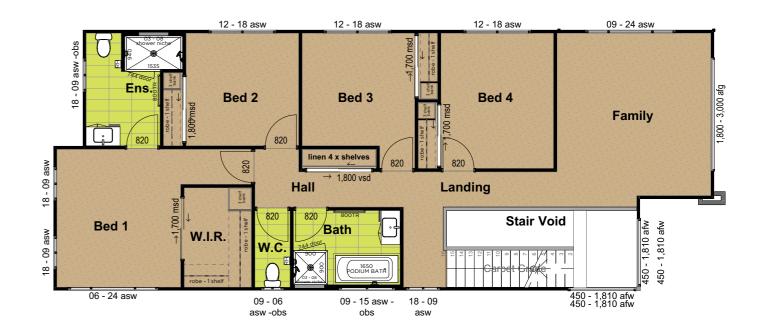

Plan
Floor Covering - Upper
SCALE: 1:100

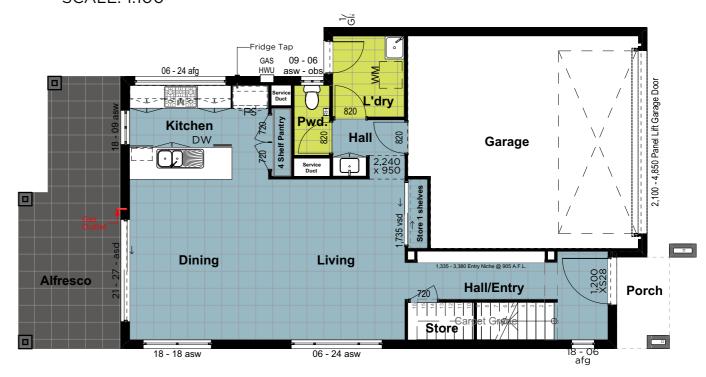



# NOTE: Fixtures, Fittings and Tile Layout remains at the builders discretion and may differ from the plans provided due to site conditions.

I/ WE APPROVE THESE DRAWINGS TO BE CORRECT AS PER CONTRACT	ARIZONA - Dimensions shall not be obtained by	client	drawing name: wind class: flood level: scale:
CORRECT AS PER CONTRACT	245 - Drake scaling. All dimensions are in millimeters unless noted otherwise.		Floor Covering Schedule N TBA TBA 1:100@A
INITIAL	(Captilovor)   Setout dimensions shall be verified		project status: soil class: BAL: revision:
INITIAL			
	project number: carried out. Any problems shall be directed to the builder for		Contract Plans  TBA   TBA   TBA   real property description: date: 10:18
INITIAL	Standard Plan   clarification & correction   REV.	DETAILS INT DATE local authority TBA	cov: Small Lot Code   drawn: TDA  check: JDA   TBA   05/03/20
			cov. Sitial Lot Code   drawn. TDA Check. 3DA   TDA