#### **BUILDING INFORMATION**

GROUND FLOOR PITCHING HEIGHT(S): 2595 FIRST FLOOR PITCHING HEIGHT(S): 2450mm FRAMES AND TRUSSES: STEEL ROOF PITCH (U.N.O.): 3 0° ELECTRICITY SUPPLY 3-PHASE GAS SUPPLY: RETICULATED SUPPLY

ROOF MATERIAL: SHEET METAL ROOF COLOUR DARK **ROOF INSULATION:** R3.5 BATTS

WIND DRIVEN ROOF VENTILATORS:

WALL MATERIAL **HEBEL VENEER** WALL COLOUR: DARK WALL INSULATION R2 0 BATTS

WALL WRAP TO CLADDING R2.0 BATTS TO INTERNAL WALLS OF LAUNDRY

R1.0 FLOOR BATTS TO BEDS 3 & 4 FLOOR INSULATION:

#### SITE & ENGINEERING INFORMATION

WIND CLASSIFICATION: N2 SITE CLASSIFICATION: SLAB CLASSIFICATION:

SLAB TO BE 85mm THICK (U.N.O.) WITH REINFORCEMENT TO ENGINEERS SPECIFICATIONS & DETAILS OVER A 200 µm WATERPROOF MEMBRANE ON A BED OF FREE DRAINING COARSE SAND (WHERE SPECIFIED)

PROVIDE HEBEL CONTROL JOINTS IN ACCORDANCE WITH MANUFACTURER'S

ALL STEEL FRAMING TO BE DESIGNED TO AS 4100-2020 OR AS/NZS 4600-2018

#### **BASIX AREAS**

CONDITIONED 129.29 UNCONDITIONED 12.63

#### TOTAL FLOOR AREAS

ALFRESCO 10.29 BALCONY 3.50 GARAGE 35.46 LIVING (FIRST FLOOR) 86.27 LIVING (GROUND FLOOR) 83.27 **PATIO** 3.73 222.52 m<sup>2</sup>

#### SUSTAINABILITY COMMITMENTS

#### WATER COMMITMENTS

3 STAR (> 7.5 BUT <= 9 L/MIN) SHOWER HEADS

4 STAR TOILET SUITES 4 STAR KITCHEN TAPS **5 STAR BATHROOM TAPS** 

131.19 m<sup>2</sup> TOTAL ROOF AREA

2100 L WATER TANK(S) MINIMUM CAPACITY 86.51 m<sup>2</sup> MINIMUM ROOF AREA TO TANK(S)

#### RAINWATER TANK(S) TO BE CONNECTED TO:

- AT LEAST ONE OUTDOOR TAP
- ALL TOILETS
- WASHING MACHINE

NO RETICULATED RECYCLED WATER SUPPLY

0 m2 GARDEN/LAWN AREA

#### **ENERGY COMMITMENTS**

#### **HOT WATER SYSTEM**

- GAS CONTINUOUS FLOW - 6 STAR

#### **HEATING SYSTEM**

- 1-PHASE REVERSE CYCLE AIR CONDITIONING EER 3.0 - 3.5

#### **COOLING SYSTEM**

- 1-PHASE REVERSE CYCLE AIR CONDITIONING EER 3.0 - 3.5

#### **VENTILATION (EXHAUST FANS)**

- AT LEAST ONE BATHROOM:
- DUCTED TO OUTSIDE AIR, MANUAL SWITCH ON/OFF
- KITCHEN RANGEHOOD:
- DUCTED TO OUTSIDE AIR, MANUAL SWITCH ON/OFF
- LAUNDRY:

DUCTED TO OUTSIDE AIR, MANUAL SWITCH ON/OFF

#### PRIMARY FLUORESCENT/LED LIGHTING INCLUDING COVER

- 4 BEDROOMS/STUDY, DEDICATED
- 3 LIVING/DINING AREAS, DEDICATED
- KITCHEN, DEDICATED
- ALL BATHROOMS/TOILETS, DEDICATED
- LAUNDRY, DEDICATED
- ALL HALLWAYS, DEDICATED

#### **NATURAL LIGHTING TO**

- 1 BATHROOMS/TOILETS

#### ALTERNATIVE ENERGY

#### OTHER

- GAS COOKTOP, ELECTRIC OVEN
- FIXED OUTDOOR CLOTHESLINE BY BUILDER
- WELL VENTILATED FRIDGE SPACE

#### **BASIX CERTIFICATE:**

- 1110323S.02 (08 SEPTEMBER 2020)

### BAL-LOW BUSHFIRE REQUIREMENTS

NO SPECIAL CONSTRUCTION REQUIREMENTS

## AGGRESSIVE SOIL REQUIREMENTS

AGGRESSIVE SOIL REQUIREMENTS PROVIDE ADDITIONAL STRUCTURAL REQUIREMENTS, DUE TO BUILDING IN AN 'AGGRESSIVE SOIL ENVIRONMENT'. THIS SHALL

- INCLUDE THE FOLLOWING: PROVIDE 25MPa CONCRETE TO THE PIERS AND FLOOR SLABS IN LIEU OF STANDARD.
- PROVIDE HIGH IMPACT MEMBRANE BELOW THE FLOOR SLAB.
- PROVIDE A MIN. 50mm BLINDING LAYER OF SAND UNDERNEATH THE FLOOR STRUCTURE.
- PROVIDE POLYETHYLENE DAMP PROOF COURSE TO THE EXTERNAL WALLS IN LIEU OF STANDARD.
- USE EXPOSURE GRADE MORTAR BELOW DAMP PROOF COURSE IN LIEU OF STANDARD.
- USE EXPOSURE GRADE BRICKWORK FROM OUR STANDARD RANGE BELOW THE DAMP PROOF COURSE.



88B CHECKED AND ACKNOWLEDGED APPLICABLE CLAUSE(S): 1,7,8,9,10,12,16,17,18,& 19

APPLICATION TO BE ASSESSED BY CAMPBELLTOWN CITY COUNCIL (NSW) DEVELOPMENT APPLICATION

MCDONALD JONES COMMUNITIES PTY LTD T/A COMPLETE BY MCDONALD JONES (ACN 603 418 364). THIS DRAWING IS AN ORIGINAL ARTISTIC WORK WITHIN THE MEANING OF THE COPYRIGHT ACT 1968 (CTH). MCDONALD JONES COMMUNITIES PTY LTD IS THE OWNER OF COPYRIGHT IN THIS DRAWING. YOU HEREBY AGREE AND UNDERTAKE THAT YOU WILL NOT IN ANY WAY REPRODUCE, COPY, MODIFY, USE OR TAKE ADVANTAGE OF THE DRAWING TO BUILD A HOUSE BASED ON THIS PLAN (WHETHER IN WHOLE OR IN PART) WITHOUT THE

**12** complete

1		DRAWING	DRAWN		
	5	ENGINEERS DETAILS	ZOV	2020.09.25	
	6	HOUSE & FACADE NAMES	ZOV	2020.09.29	
	7	SHADOWS ADJUSTED TO COUNCILS REQ.	ZOV	2020.10.22	
	8	AMENDED AS TO RFI	ZOV	2020.11.14	
)	9	CONSTRUCTION PLAN	ZOV	2020.12.14	

1	CLIENT:			LOT No.:
1	COMPLETE BY MCDONALD	6060		
	ADDRESS:	DP No.:		
	7 COMMISSIONERS DRIVE	1238895		
	SUBURB:	POSTCODE:	COUNCIL:	SECTION No.:
	DENHAM COURT	2565	CAMPBELLTOWN	N/A
_				

HOUSE DESIGN:	HOUSE CODE:	
LANGDALE THREE		
FACADE DESIGN:	FACADE CODE:	
ANDERSON		
SHEET TITLE:	SCALES:	SHEET No.:
COVER SHEET		1 / 20

DATE:

ZOV

14/12/2020

DRAFTING OFFICE:

DRAFTER:

**SYDNEY** 


DO NOT SCALE DRAWINGS, USE GURED DIMENSIONS ONLY. CHECK ND VERIEY DIMENSIONS AND LEVELS OR TO THE COMMENCEMENT OF AN WORK. ALL DISCREPANCIES TO BE PORTED TO THE DRAFTING OFFICE

**ESTIMATOR:** 

**TUL** 

951502

**CONSTRUCTION PLANS** 

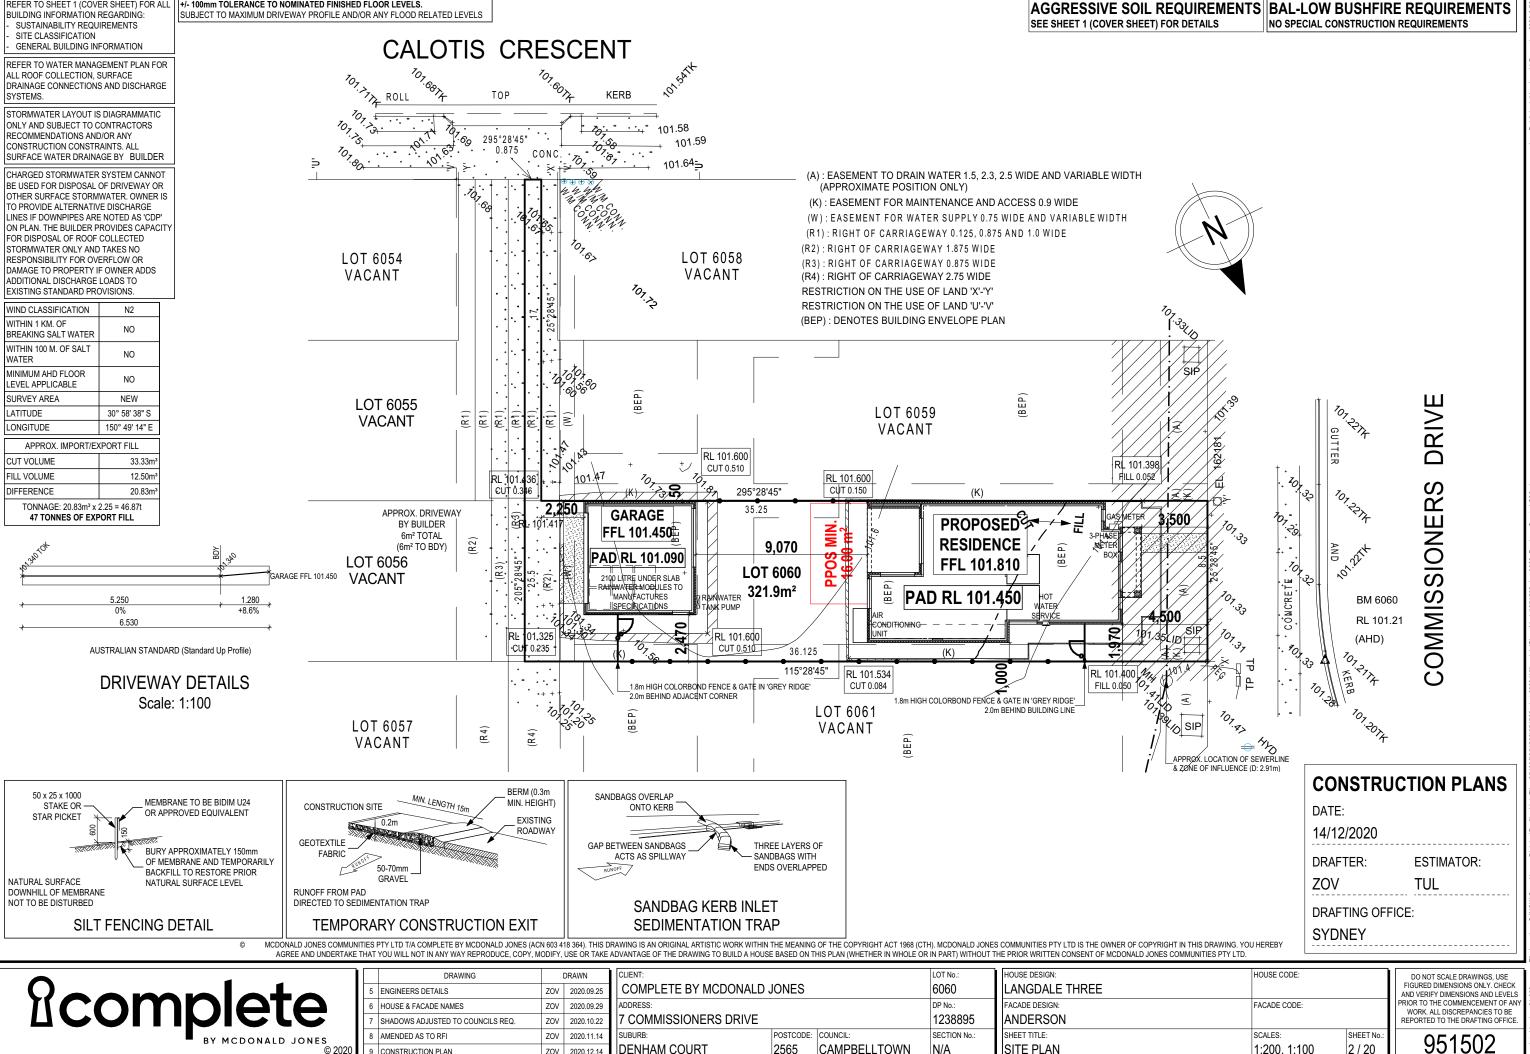

CAMPBELLTOWN

N/A

SITE PLAN

2565

DENHAM COURT

ZOV 2020.12.14

9 CONSTRUCTION PLAN

REFER TO SHEET 1 (COVER SHEET) FOR ALL

+/- 100mm TOLERANCE TO NOMINATED FINISHED FLOOR LEVELS.

1:200, 1:100

2 / 20

REFER TO SHEET 1 (COVER SHEET) FOR ALL PROVIDE AND INSTALL SINGLE PHASE REVERSE BAL-LOW BUSHFIRE PREQUIREMENTS **HEBEL ARTICULATION JOINT LOCATION** BUILDING INFORMATION REGARDING: AGGRESSIVE SOIL REQUIREMENTS NO SPECIAL CONSACTOR REQUIREMENTS Area (m²)
ALFRESCO 10.29 SUSTAINABILITY REQUIREMENTS TO MANUFACTURERS SPECIFICATIONS OSITIONING OF OUTLETS AND THE FINAL LOCATION SEE SHEET 1 (COVER SHEET) FOR DETAILS SITE CLASSIFICATION OF THE RETURN AIR GRILLE WILL BE DETERMINED ON GENERAL BUILDING INFORMATION SITE BY THE AIR CONDITIONING CONTRACTOR AND IS BALCONY 3.50 CDP CHARGED DOWNPIPE DIRECTED TO TANK SUBJECT TO TRUSS LAYOUT AND ANY OTHER GARAGE 35.46 CONSTRUCTION CONSTRAINTS. LIVING (FIRST FLOOR) 86.27 STANDARD DOWNPIPE DIRECTED FRAME MANUFACTURER TO PROVIDE CLEARANCE LIVING (GROUND FLOOR) 83.27 TO STORMWATER DISCHARGE FOR PASSAGE OF FAN COIL UNIT FROM RETURN AIR OPENING TO FINAL FAN COIL LOCATION. PATIO 3.73 FIRE RESISTANT PLASTERBOARD TO BE INSTALLED BEHIND COOKTOP 222.52 m<sup>2</sup> ANY PART OF THE FASCIA, GUTTERING OR DOWNPIPE THAT IS WITHIN 450mm OF ANY BOUNDARY IS TO BE ALL EXTERIOR STEPS AND LANDINGS BY NON-COMBUSTIBLE IN ACCORDANCE WITH THE NCC. OWNER UNLESS NOTED OTHERWISE ALL ALFRESCO SLABS TO BE GRADED BY ALL GROUND FLOOR BULKHEAD AND CONCRETER TO ACHIEVE APPROX. 1:100 FALL TO SQUARE SET OPENING FRAMES TO BE 2155 OUTSIDE EDGE WITH MAXIMUM CROSSFALL OF 30mm ABOVE FFL UNLESS NOTED OTHERWISE OVER ENTIRE SLAB (DOES NOT APPLY TO VERANDAH / PATIO / PORCH SLABS). REFER TO WINDOW & DOOR SCHEDULES 14,500 FOR FULL DETAILS OF ALL WINDOWS AND 12,600 900 , 1,000 ALL STAIR TREADS TO PROVIDE A MINIMUM 1,810 90, 910 90, 4,000 STAIRS 215, 900 SLIP RESISTANCE TO MEET NCC 5.930 4,330 FAM / LIV REQUIREMENTS 2,750 ALFRESCO 215, 90, 910 90, 90, 910 215, 900 5,500 215, 5,900 ENTRY UNLESS NOTED OTHERWISE ALL ROOMS ARE REFERENCED AS FOLLOWS: 350 x 350mm RENDERED HEBEL PIER WITH 75mm EZI POST TO CORE WITH COLORBOND CAPPING -75 x 75mm EZI POST METER BOX -PLUMBING STACK **ALFRESCO** (100 L) STRUCTURAL POST FAMILY/ ENTRY LIVING 5,980 GARAGE 2 x 820 CSD STRUCTURAL POST LOUNGE/ PDR 🏵 BEAM OVER TO MANUF. SPECS HOME PROVIDE CONDUIT D03 **CONTRACTOR** TO ISLAND BENCH MAN HOLE (AC) /RAINWATER TV SUPPORT FRAME TO (D06) RECESS (D-FRAM-**DINING** 2,390 **KITCHEN** BEAM OVER TO ENG. SPECS SETDOWN 2100x820 (889) 2100 LITRE UNDER SLAB RAINWATER MODIJIES TO-CDP SF2100x1470 350 x 350mm RENDERED HEBEL PIER WITH 75mm EZI POST TO 5.500 215, , -75 x 75mm EZI POST 1,245 GAS 600 600 GAS 600 EL \* 750 \* 889 , , , 350 -PLUMBING STACK FRAMED BULKHEAD TO KITCHEN 5,930 CUPBOARDS 2287 OFF FFL AND 630 FROM WALL (D-FRAM-BULK008) 1,720 PDR 180 4.000 FLOOR PLAN LEGEND 1,720 LDRY 180 4,000 LOUNGE/ HOME THEATRE 215, HOB SPOUT / WALL SPOUT FACE BRICK / COMMON BRICK 7,510 5,990 1,000 14,500 HEBEL SOUND INSULATION **CONSTRUCTION PLANS** BRICK ARTICULATION JOINT DENOTES DRAWER SIDE DATE:

EXHAUST FAN

LOAD BEARING WALL L.B.W THIS DOOR OPENS FIRST

SMOKE ALARM LIFT OFF HINGE WATER POINT

GAS BAYONET

ALL DIMENSIONS ARE FRAME DIMENSIONS

MCDONALD JONES COMMUNITIES PTY LTD T/A COMPLETE BY MCDONALD JONES (ACN 603 418 364). THIS DRAWING IS AN ORIGINAL ARTISTIC WORK WITHIN THE MEANING OF THE COPYRIGHT ACT 1968 (CTH). MCDONALD JONES COMMUNITIES PTY LTD IS THE OWNER OF COPYRIGHT IN THIS DRAWING. YOU HEREBY AGREE AND UNDERTAKE THAT YOU WILL NOT IN ANY WAY REPRODUCE, COPY, MODIFY, USE OR TAKE ADVANTAGE OF THE DRAWING TO BUILD A HOUSE BASED ON THIS PLAN (WHETHER IN WHOLE OR IN PART) WITHOUT THE PRIOR WRITTEN CONSENT OF MCDONALD JONES COMMUNITIES PTY LTD.

<b>Bcom</b>	p	let	:e
	■ BY M	1CDONALD	JONES

Ī			DRAWING	DRAWN			
		5	ENGINEERS DETAILS	ZOV	2020.09.25		
		6	HOUSE & FACADE NAMES	ZOV	2020.09.29		
		7	SHADOWS ADJUSTED TO COUNCILS REQ.	ZOV	2020.10.22		
		8	AMENDED AS TO RFI	ZOV	2020.11.14		
)	Ш	q	CONSTRUCTION PLAN	ZOV	2020 12 14		

一.					
- 1	CLIENT:			LOT No.:	Н
5	COMPLETE BY MCDONALD	JONES		6060	L
9	ADDRESS:			DP No.:	F.
2	7 COMMISSIONERS DRIVE		1238895	P	
4	SUBURB:	POSTCODE:	COUNCIL:	SECTION No.:	S
4	DENHAM COURT	2565	CAMPBELLTOWN	N/A	(

HOUSE BESIEW	HOUSE CORE		$\equiv$
HOUSE DESIGN:	HOUSE CODE:	- 1	Ι.
LANGDALE THREE			4
FACADE DESIGN:	FACADE CODE:		PF
ANDERSON			
SHEET TITLE:	SCALES:	SHEET No.:	
GROUND FLOOR PLAN	1:100	4 / 20	

DO NOT SCALE DRAWINGS, USE FIGURED DIMENSIONS ONLY. CHECK AND VERIEY DIMENSIONS AND LEVELS RIOR TO THE COMMENCEMENT OF AN WORK. ALL DISCREPANCIES TO BE REPORTED TO THE DRAFTING OFFICE

951502

14/12/2020

**ESTIMATOR:** DRAFTER:

**TUL** 

DRAFTING OFFICE:

**SYDNEY** 

REFER TO SHEET 1 (COVER SHEET) FOR ALL BUILDING INFORMATION REGARDING:
- SUSTAINABILITY REQUIREMENTS
- SITE CLASSIFICATION
- GENERAL BUILDING INFORMATION

CDP CHARGED DOWNPIPE DIRECTED
TO TANK
SDD STANDARD DOWNPIPE DIRECTED

FIRE RESISTANT PLASTERBOARD TO BE INSTALLED BEHIND COOKTOP

TO STORMWATER DISCHARGE

ALL EXTERIOR STEPS AND LANDINGS BY OWNER UNLESS NOTED OTHERWISE

ALL FIRST FLOOR BULKHEAD AND SQUARE SET OPENING FRAMES TO BE 2155 ABOVE FFL UNLESS NOTED OTHERWISE

REFER TO WINDOW & DOOR SCHEDULES FOR FULL DETAILS OF ALL WINDOWS AND DOORS

ALL STAIR TREADS TO PROVIDE A MINIMUM SLIP RESISTANCE TO MEET NCC

FIRST FLOOR WINDOW OPENINGS TO BE RESTRICTED AS REQUIRED BY THE NCC

PROVIDE FLOOR WASTE AND OVERFLOW SPITTERS TO UPPER FLOOR TANKED BALCONIES WHERE APPLICABLE AS PER: - G-FACA-BALC02 (PFC/BRICKWORK) - G-FRAM-BALC001 (LIGHTWEIGHT CLADDING)

UNLESS NOTED OTHERWISE ALL ROOMS ARE REFERENCED AS FOLLOWS:



# HEBEL ARTICULATION JOINT LOCATION TO MANUFACTURERS SPECIFICATIONS

# BAL-LOW BUSHFIRE REQUIREMENTS NO SPECIAL CONSTRUCTION REQUIREMENTS


 O OF EDIAL OUND INCOMINE NEWSTINE MENTO						
Total Floor Areas						
Area Name	Area (m					
ALFRESCO	10.29					
BALCONY	3.50					
GARAGE	35.46					
LIVING (FIRST FLOOR)	86.27					
LIVING (GROUND FLOOR)	83.27					
PATIO	3.73					
	222.52 1					


PROVIDE AND INSTALL SINGLE PHASE REVERSE
CYCLE AIR CONDITIONING SYSTEM. NUMBER AND
POSITIONING OF OUTLETS AND THE FINAL LOCATION
OF THE RETURN AIR GRILLE WILL BE DETERMINED ON
SITE BY THE AIR CONDITIONING CONTRACTOR AND IS
SUBJECT TO TRUSS LAYOUT AND ANY OTHER
CONSTRUCTION CONSTRAINTS.

FRAME MANUFACTURER TO PROVIDE CLEARANCE
FOR PASSAGE OF FAN COIL UNIT FROM RETURN AIR
OPENING TO FINAL FAN COIL LOCATION.

ANY PART OF THE FASCIA, GUTTERING OR DOWNPIPE THAT IS WITHIN 450mm OF ANY BOUNDARY IS TO BE NON-COMBUSTIBLE IN ACCORDANCE WITH THE NCC.

ALL ALFRESCO SLABS TO BE GRADED BY CONCRETER TO ACHIEVE APPROX. 1:100 FALL TO OUTSIDE EDGE WITH MAXIMUM CROSSFALL OF 30mm OVER ENTIRE SLAB (DOES NOT APPLY TO VERANDAH / PATIO / PORCH SLABS).

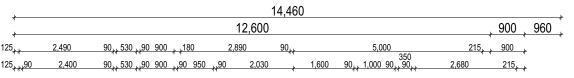

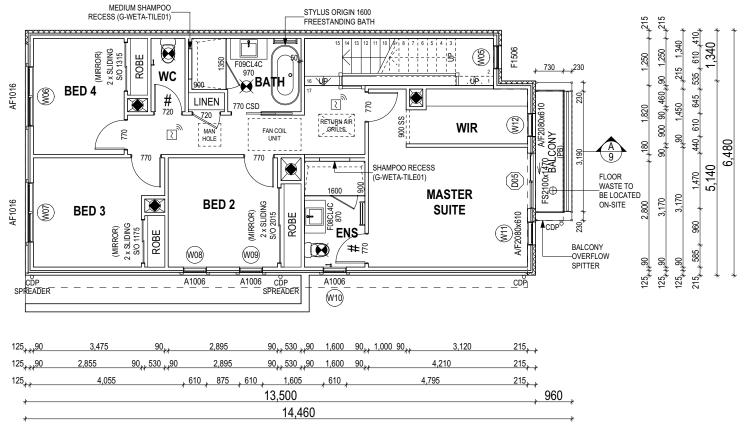

### FLOOR PLAN LEGEND

HS/WS HOB SPOUT/WALL SPOUT

FACE BRICK / COMMON BRICK
SOUND INSULATION

AJ BRICK ARTICULATION JOINT3D DENOTES DRAWER SIDE

EXHAUST FAN

L.B.W LOAD BEARING WALL

THIS DOOR OPENS FIRST
SMOKE ALARM

LIFT OFF HINGE

#

WATER POINT

FRIDGE WATER POINT GAS BAYONET



MCDONALD JONES COMMUNITIES PTY LTD T/A COMPLETE BY MCDONALD JONES (ACN 603 418 364). THIS DRAWING IS AN ORIGINAL ARTISTIC WORK WITHIN THE MEANING OF THE COPYRIGHT ACT 1968 (CTH), MCDONALD JONES COMMUNITIES PTY LTD IS THE OWNER OF COPYRIGHT IN THIS DRAWING. YOU HEREBY AGREE AND UNDERTAKE THAT YOU WILL NOT IN ANY WAY REPRODUCE, COPY, MODIFY, USE OR TAKE ADVANTAGE OF THE DRAWING TO BUILD A HOUSE BASED ON THIS PLAN (WHETHER IN WHOLE OR IN PART) WITHOUT THE PRIOR WRITTEN CONSENT OF MCDONALD JONES COMMUNITIES PTY LTD.

1,000 90, 1,040 90,

1,360 90,

2complete
BY MCDONALD JONES
6 2020

1		DRAWING	ı	DRAWN
ı	5	ENGINEERS DETAILS	ZOV	2020.09.25
ı	6	HOUSE & FACADE NAMES	ZOV	2020.09.29
ı	7	SHADOWS ADJUSTED TO COUNCILS REQ.	ZOV	2020.10.22
ı	8	AMENDED AS TO RFI	ZOV	2020.11.14
١	9	CONSTRUCTION PLAN	ZOV	2020.12.14

1	CLIENT:			LOT No.:	
1	COMPLETE BY MCDONALD	6060	Ì		
	ADDRESS:			DP No.:	i
	7 COMMISSIONERS DRIVE	1238895	Ì		
	SUBURB:	POSTCODE:	COUNCIL:	SECTION No.:	l
1	DENHAM COURT	2565	CAMPBELLTOWN	N/A	ĺ

HE FRIOR WRITTEN CONSENT OF MICDONALD JONES CON	WINDNITIES FIT LID.		_
HOUSE DESIGN:	HOUSE CODE:		_
LANGDALE THREE			A
FACADE DESIGN:	FACADE CODE:		PF
ANDERSON			
SHEET TITLE:	SCALES:	SHEET No.:	
FIRST FLOOR PLAN	1:100	5 / 20	

DO NOT SCALE DRAWINGS, USE
FIGURED DIMENSIONS ONLY, CHECK
AND VERIFY DIMENSIONS AND LEVELS
PRIOR TO THE COMMENCEMENT OF ANY
WORK, ALL DISCREPANCIES TO BE
REPORTED TO THE DRAFTING OFFICE.

**ESTIMATOR:** 

**CONSTRUCTION PLANS** 

DATE:

14/12/2020

DRAFTING OFFICE:

DRAFTER:

**SYDNEY** 

951502

File Location: G:NNSW Spec Homes Division\Draffing\Uob Files 951000951500\951502 - Lot 6060 Willowdale\Plan\_W

0,3 ASSUME LOOKING FROM OUTSIDE

1,2 ASSUME LOOKING FROM INSIDE

ID CODE°	ROOM	HEIGHT	WIDTH I	PERIMETER	AREA FRAME (m²) TYPE	BAL RATING	SILL TYPE	ORIENT.	GLAZING AREA (m²)	ADDITIONAL INFORMATION <sup>3</sup>	only of
W01 F1506	STAIRWELL	1,460	610	4,140	0.89 ALUMINIUM	N/A	NONE	NW	0.75 CLEAR, TOUGHENED		
W02 AA/FF2080x1570	DINING	2,080	1,570	7,300	3.27 ALUMINIUM	N/A	NONE	SE	2.54 CLEAR	BP 620, MP 785/785	
W03 A/F2080x610	LOUNGE / HOME THEATRE	2,080	610	5,380	1.27 ALUMINIUM	N/A	NONE	NW	0.94 CLEAR	BP 620	
W04 AA/FF2080x1570	LOUNGE / HOME THEATRE	2,080	1,570	7,300	3.27 ALUMINIUM	N/A	NONE	NW	2.54 CLEAR	BP 620, MP 785/785	- l
W05 F1506	STAIRWELL	1,460	610	4,140	0.89 ALUMINIUM	N/A	NONE	NW	0.75 CLEAR		
W06 AF1016	BED 4	1,030	1,570	5,200	1.62 ALUMINIUM	N/A	NONE	SE	1.28 CLEAR	MP 785	
W07 AF1016	BED 3	1,030	1,570	5,200	1.62 ALUMINIUM	N/A	NONE	SE	1.28 CLEAR	MP 785	
W08 A1006	BED 2	1,030	610	3,280	0.63 ALUMINIUM	N/A	NONE	NE	0.44 CLEAR		
W09 A1006	BED 2	1,030	610	3,280	0.63 ALUMINIUM	N/A	NONE	NE	0.44 CLEAR		
W10 A1006	ENS	1,030	610	3,280	0.63 ALUMINIUM	N/A	NONE	NE	0.44 OBSCURE, TOUGHENED		
W11 A/F2080x610	MASTER SUITE	2,080	610	5,380	1.27 ALUMINIUM	N/A	NONE	NW	0.94 CLEAR	BP 620	
W12 A/F2080x610	WIR	2,080	610	5,380	1.27 ALUMINIUM	N/A	NONE	NW	0.94 CLEAR	BP 620	
					17.26				13.28		

#### **EXTERIOR DOOR SCHEDULE**

0,1 ASSUME LOOKING FROM OUTSIDE

ID CODE°	ROOM	HEIGHT WIDTH	AREA FRAME (m²) TYPE	BAL RATIN	G SILL TYPE	GLAZING	ORIENT.	DOOR TYPE ADDITIONAL INFORMATION <sup>1</sup>
D01 920	ENTRY	2,106 967	2.04 TIMBER	N/A	SNAP HEADER	DOOR(S): CLEAR - SIDELIGHT(S): N/A	NW	SWINGING
D02 FS2124	FAMILY / LIVING	2,100 2,410	5.06 ALUMINIUM	N/A	SNAP HEADER	CLEAR, TOUGHENED	SE	SLIDING
D03 SF2118	DINING	2,100 1,810	3.80 ALUMINIUM	N/A	SNAP HEADER	CLEAR, TOUGHENED	SW	SLIDING
D04 SF2100x1470	LDRY	2,100 1,470	3.09 ALUMINIUM	N/A	SNAP HEADER	CLEAR, TOUGHENED	NE	SLIDING
D05 FS2100x1470	MASTER SUITE	2,100 1,470	3.09 ALUMINIUM	N/A	SNAP HEADER	CLEAR, TOUGHENED	NW	SLIDING
D06 2100x820	GARAGE	2,100 889	1.87 ALUMINIUM	N/A	SNAP HEADER	N\A	NE	SWINGING
D07 FSSF2131	GARAGE	2,100 3,104	6.52 ALUMINIUM	N/A	SNAP HEADER	CLEAR, TOUGHENED	NW	SLIDING

25.47 m<sup>2</sup>

#### INTERIOR DOOR SCHEDULE

QTY	CODE	TYPE	HEIGHT	WIDTH	GLAZING	ADDITIONAL INFORMATION
1	1145 SS	SQUARE SET OPENING	2,155	1,145	N/A	
1	2 x 820 CSD	CAVITY SLIDING	2,040	1,640	N/A	
1	2 x SLIDING	SLIDING	2,040	2,000	N/A	SELECT
1	2 x SLIDING	SLIDING	2,040	1,300	N/A	SELECT
1	2 x SLIDING	SLIDING	2,040	1,160	N/A	SELECT
2	720	SWINGING	2,040	720	N/A	
2	720	SWINGING	2,040	720	N/A	LIFT-OFF HINGES
4	770	SWINGING	2,040	770	N/A	
1	770	SWINGING	2,040	770	N/A	LIFT-OFF HINGES
1	770 CSD	CAVITY SLIDING	2,040	770	N/A	
1	820	SWINGING	2,040	820	N/A	
1	900 SS	SQUARE SET OPENING	2.155	900	N/A	

#### PICTURE / TV RECESS & SQUARE SET WINDOW SCHEDULE

QTY	TYPE	HEIGHT	WIDTH	AREA (m²)
1	TV RECESS	1,355	1.80	2.44

REFER TO SHEET 1 (COVER SHEET) FOR ALL BUILDING INFORMATION REGARDING: SUSTAINABILITY REQUIREMENTS - SITE CLASSIFICATION
- GENERAL BUILDING INFORMATION

# **CONSTRUCTION PLANS**

DATE: 14/12/2020

DRAFTER:

**ESTIMATOR:** ZOV

DRAFTING OFFICE:

**SYDNEY** 

BAL-LOW BUSHFIRE REQUIREMENTS NO SPECIAL CONSTRUCTION REQUIREMENTS

MCDONALD JONES COMMUNITIES PTY LTD I/A COMPLETE BY MCDONALD JONES (ACN 603 418 364). THIS DRAWING IS AN ORIGINAL ARTISTIC WORK WITHIN THE MEANING OF THE COPYRIGHT ACT 1968 (CTH). MCDONALD JONES COMMUNITIES PTY LTD IS THE OWNER OF COPYRIGHT IN THIS DRAWING. YOU HEREBY AGREE AND UNDERTAKE THAT YOU WILL NOT IN ANY WAY REPRODUCE, COPY, MODIFY, USE OR TAKE ADVANTAGE OF THE DRAWING TO BUILD A HOUSE BASED ON THIS PLAN (WHETHER IN WHOLE OR IN PART) WITHOUT THE PRIOR WRITTEN CONSENT OF MCDONALD JONES COMMUNITIES PTY LTD.



			DRAWING	ı	DRAWN
	5	5	ENGINEERS DETAILS	ZOV	2020.09.25
	6	6	HOUSE & FACADE NAMES	ZOV	2020.09.29
	7	7	SHADOWS ADJUSTED TO COUNCILS REQ.	ZOV	2020.10.22
	8	8	AMENDED AS TO RFI	ZOV	2020.11.14
)	[	9	CONSTRUCTION PLAN	ZOV	2020.12.14

7	CLIENT:	LOT No.:		
5	COMPLETE BY MCDONALD	6060		
9	ADDRESS:	DP No.:		
2	7 COMMISSIONERS DRIVE	1238895		
4	SUBURB:	POSTCODE:	COUNCIL:	SECTION No.:
4	DENHAM COURT	2565	CAMPBELLTOWN	N/A

HOUSE DESIGN:	HOUSE CODE:	
LANGDALE THREE		
FACADE DESIGN:	FACADE CODE:	
ANDERSON		
SHEET TITLE:	SCALES:	SHEET No.:
WINDOW & DOOR SCHEDULES		6 / 20


DO NOT SCALE DRAWINGS, USE FIGURED DIMENSIONS ONLY. CHECK AND VERIFY DIMENSIONS AND LEVELS PRIOR TO THE COMMENCEMENT OF ANY WORK, ALL DISCREPANCIES TO BE REPORTED TO THE DRAFTING OFFICE.

951502

**BAL-LOW BUSHFIRE REQUIREMENTS** 

### FRONT ELEVATION (MAIN DWELLING)

Scale: 1:100

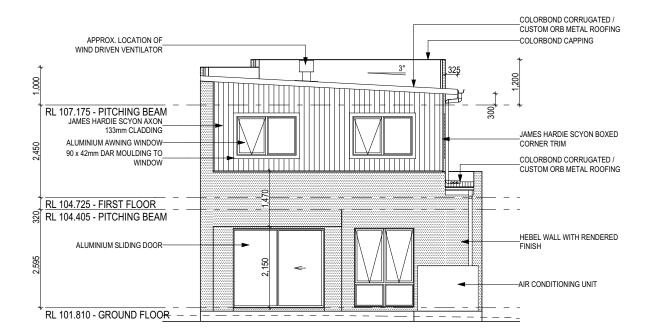

REAR ELEVATION (MAIN DWELLING)


Scale: 1:100

REFER TO SHEET 1 (COVER SHEET) FOR ALL BUILDING INFORMATION REGARDING: SUSTAINABILITY REQUIREMENTS SITE CLASSIFICATION
GENERAL BUILDING INFORMATION

SH = SNAP HEADER SILL

FIRST FLOOR WINDOW OPENINGS TO BE RESTRICTED AS REQUIRED BY THE NCC

RL 107.175 - PITCHING BEAM

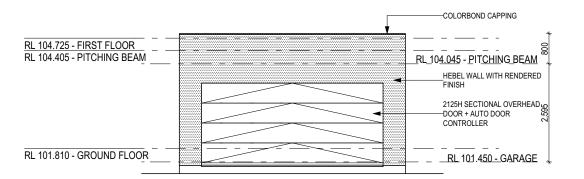

FRONT ELEVATION (GARAGE)


Scale: 1:100

RL 107.175 - PITCHING BEAM



**REAR ELEVATION (GARAGE)** 

Scale: 1:100

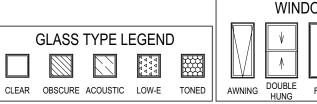

WINDOW TYPE LEGEND FIXED

DATE: 14/12/2020 **ESTIMATOR:** DRAFTER: TUL DRAFTING OFFICE:

**SYDNEY** 

ALL CUT/FILL BATTERS ARE 1:1 MAX GRADIENT MCDONALD JONES COMMUNITIES PTY LTD T/A COMPLETE BY MCDONALD JONES (ACN 603 418 364). THIS DRAWING IS AN ORIGINAL ARTISTIC WORK WITHIN THE MEANING OF THE COPYRIGHT ACT 1968 (CTH). MCDONALD JONES COMMUNITIES PTY LTD IS THE OWNER OF COPYRIGHT IN THIS DRAWING. YOU HEREBY AGREE AND UNDERTAKE THAT YOU WILL NOT IN ANY WAY REPRODUCE, COPY, MODIFY, USE OR TAKE ADVANTAGE OF THE DRAWING TO BUILD A HOUSE BASED ON THIS PLAN (WHETHER IN WHOLE OR IN PART) WITHOUT THE PRIOR WRITTEN CONSENT OF MCDONALD JONES COMMUNITIES PTY LTD.

2 Complete

	Ì		DRAWING	ı	DRAWN
	ı	5	ENGINEERS DETAILS	ZOV	2020.09.
		6	HOUSE & FACADE NAMES	ZOV	2020.09.
		7	SHADOWS ADJUSTED TO COUNCILS REQ.	ZOV	2020.10.
	ı	8	AMENDED AS TO RFI	ZOV	2020.11.
0	ı	9	CONSTRUCTION PLAN	ZOV	2020.12.


	CLIENT:			LOT No.:
.25	COMPLETE BY MCDONALD	IONES		6060
.29	ADDRESS:			DP No.:
.22	7 COMMISSIONERS DRIVE			1238895
.14	SUBURB:	POSTCODE:	COUNCIL:	SECTION No.:
.14	DENHAM COURT	2565	CAMPBELLTOWN	N/A

1	HOUSE DESIGN:	HOUSE CODE:	
	LANGDALE THREE		
	FACADE DESIGN:	FACADE CODE:	
	ANDERSON		
	SHEET TITLE:	SCALES:	SHEET No.:
	ELEVATIONS	1:100	7 / 20

DO NOT SCALE DRAWINGS, USE FIGURED DIMENSIONS ONLY. CHECK AND VERIEY DIMENSIONS AND LEVELS PRIOR TO THE COMMENCEMENT OF AN WORK. ALL DISCREPANCIES TO BE REPORTED TO THE DRAFTING OFFICE

951502

**CONSTRUCTION PLANS** 

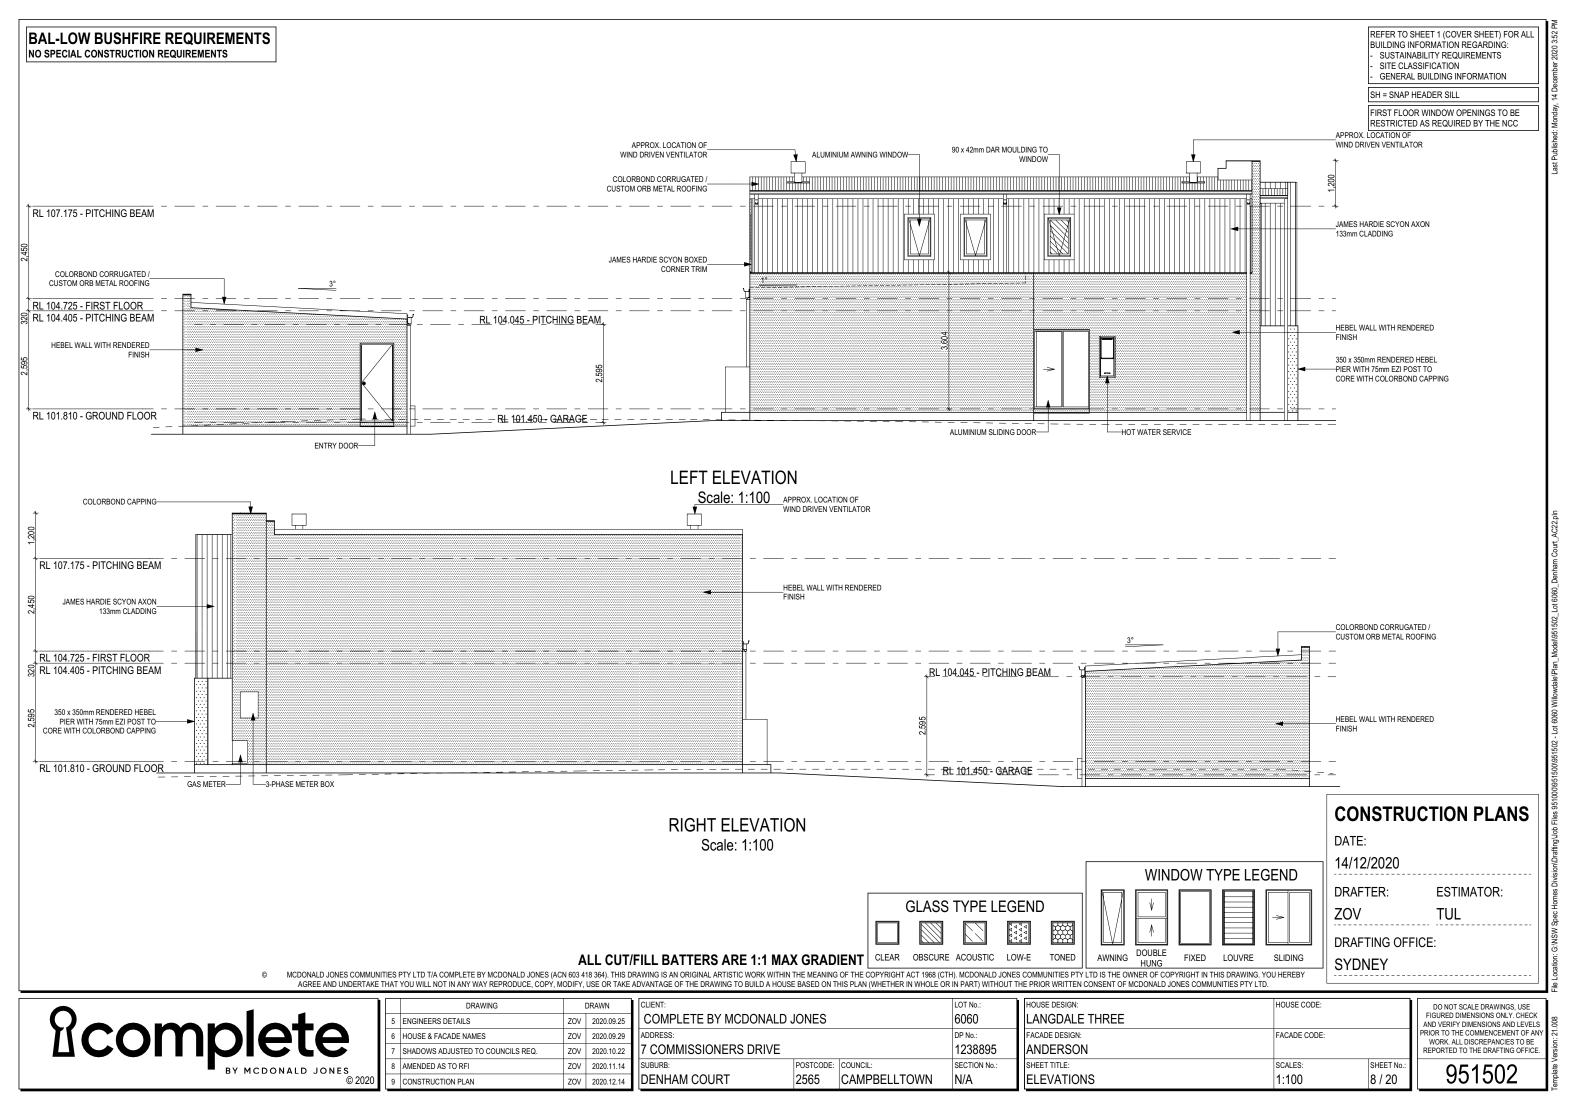


REFER TO SHEET 1 (COVER SHEET) FOR ALL BUILDING INFORMATION REGARDING: SUSTAINABILITY REQUIREMENTS SITE CLASSIFICATION
GENERAL BUILDING INFORMATION

FLOOR TILES SHOWN ON PLAN DO NOT INDICATE THE SIZE OR JOINT LOCATIONS OF THE ACTUAL FLOOR TILES. TIMBER FLOORING SHOWN ON PLAN DOES NOT INDICATE THE BOARD SIZE OR DIRECTION OF THE ACTUAL FLOORING.


#### **COVERINGS LEGEND**


NO COVERING COVER GRADE CONCRETE CARPET TIMBER/LAMINATE (BY OWNER) TILE (STANDARD WET AREAS) TILE (UPGRADED AREAS)

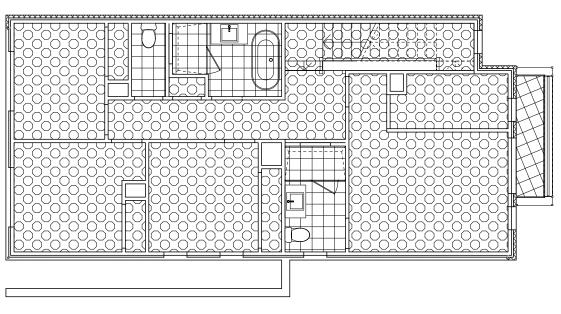

FLOOR COVERINGS (FIRST FLOOR)

Scale: 1:100

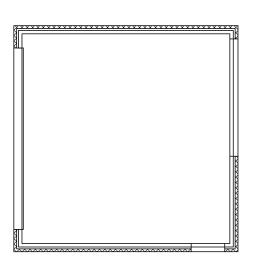

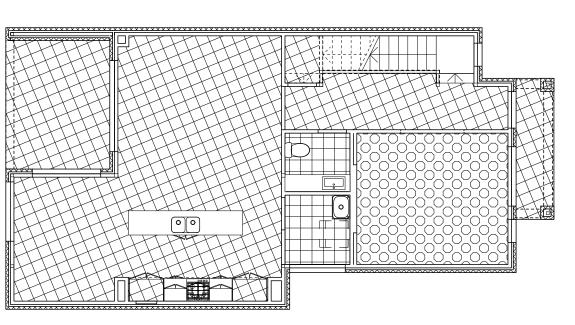

FLOOR COVERINGS (GROUND FLOOR)

Scale: 1:100

BAL-LOW BUSHFIRE REQUIREMENTS NO SPECIAL CONSTRUCTION REQUIREMENTS

MCDONALD JONES COMMUNITIES PTY LTD T/A COMPLETE BY MCDONALD JONES (ACN 603 418 364). THIS DRAWING IS AN ORIGINAL ARTISTIC WORK WITHIN THE MEANING OF THE COPYRIGHT ACT 1968 (CTH). MCDONALD JONES COMMUNITIES PTY LTD IS THE OWNER OF COPYRIGHT IN THIS DRAWING. YOU HEREBY AGREE AND UNDERTAKE THAT YOU WILL NOT IN ANY WAY REPRODUCE, COPY, MODIFY, USE OR TAKE ADVANTAGE OF THE DRAWING TO BUILD A HOUSE BASED ON THIS PLAN (WHETHER IN WHOLE OR IN PART) WITHOUT THE PRIOR WRITTEN CONSENT OF MCDONALD JONES COMMUNITIES PTY LTD.

ı		DRAWING	l	DRAWN
	5	ENGINEERS DETAILS	ZOV	2020.09.25
	6	HOUSE & FACADE NAMES	ZOV	2020.09.29
	7	SHADOWS ADJUSTED TO COUNCILS REQ.	ZOV	2020.10.22
	8	AMENDED AS TO RFI	ZOV	2020.11.14

ı	DRAWN	CLIENT:	LOT No.:		
ZOV	2020.09.25	COMPLETE BY MCDONALD	6060		
ZOV	2020.09.29	ADDRESS:	DP No.:		
ZOV	2020.10.22	7 COMMISSIONERS DRIVE	1238895		
ZOV	2020.11.14	SUBURB:	POSTCODE:	COUNCIL:	SECTION No.:
ZOV	2020.12.14	DENHAM COURT	2565	CAMPBELLTOWN	N/A

1	HOUSE DESIGN:	HOUSE CODE:	
	LANGDALE THREE		
	FACADE DESIGN:	FACADE CODE:	
	ANDERSON		
	SHEET TITLE:	SCALES:	SHEET No.:
	FLOOR COVERINGS	1:100	18 / 20

DO NOT SCALE DRAWINGS, USE FIGURED DIMENSIONS ONLY. CHECK AND VERIFY DIMENSIONS AND LEVELS PRIOR TO THE COMMENCEMENT OF AN'
WORK. ALL DISCREPANCIES TO BE
REPORTED TO THE DRAFTING OFFICE.

**ESTIMATOR:** 

TUL

DATE:

ZOV

14/12/2020

DRAFTING OFFICE:

DRAFTER:

**SYDNEY** 

951502

2 Complete BY MCDONALD JONES © 2020 9 CONSTRUCTION PLAN **CONSTRUCTION PLANS**