Working Drawings

1	Cover Sheet	N/A
2	Legends / Notes	N/A
3	Site Plan	1:200 @ A3
4	Floor Plan	1:100 @ A3
5	Elevations 1 of 2	1:100 @ A3
6	Elevations 2 of 2	1:100 @ A3
7	Sections / Details	as per dwg.
8	Slab Layout	1:100 @ A3
9	Electrical Plan	1:100 @ A3
10	Bracing Plan	1:100 @ A3
11	Landscaping Plan	1:200 @ A3
12	Internal Elevations 1 of 2	1:50 @ A3
13	Internal Elevations 2 of 2	1:50 @ A3



Issue	Date	Description
WD - A	02/02/21	BA Issue
WD - B	08/02/21	Design Changes

Proposed New Building For:

Freedom Developments

Lot 162 Davidson Circuit, Park Ridge (Carvers Reach Estate)



ALL WORKS SHALL COMPLY WITH BUT NOT LIMITED TO THE BUILDING CODE OF AUSTRALIA AND THE CURRENT AUSTRALIAN STANDARDS

General Notes

- Dishwasher provision under sink drainer including cold water connection & GPO
- Ventilation to internal wc / bath to be an exhaust fan in accordance with BCA F5.4 & AS 1668.2
- O/head cupboards to 2100mm AFL with bulkhead over as per detail
- All openings to have 2100mm AFL
- Robe fitout (1) shelf with hanging rail
- PVC Downpipes
- Lift off hinges to w/c, Ensuite, Bathroom
- Dimensions are to be verified prior to commencement of work
- Given dimensions are to have priority to scaled dimensions
- All stairs are to have 190mm maximum risers and 240mm minimum goings
- \bullet All wet areas to be in accordance with the current Building Code of Australia 3.8.1 & current AS.
- Floor wastes to wet areas
- Denotes Smoke Detector to be interconnected & hardwired

Site Notes

- Contractor to verify all boundary clearances & site set-out dimensions prior to commencement of construction
- Levels & contours are based on assumed datum. Prior to construction the relevant authority should be contacted for possible minimum floor level requirements & flood information
- Retaining walls greater than 1m high (cut or fill) are required to be engineer designed & certified
- Batters to comply appropriate soil classification described in table 3.1.1.1. BCA Vol.2.
- $\bullet \ \ \text{Vehicular cross-over to be constructed as per local council requirements and/or approval}$
- Driveways, paths, porch, alfresco area finish as per specifications
- \bullet Scrape away vegetation & cut & fill to provide a level building platform
- Finish surface to be graded away from house at minimum of 1:20 for at least 1m
- Surface water to be channelled to council stormwater drainage system
- The driveway & pathways indicated on plan are suggested layouts
- · All ground levels are approximate only
- All works to be constructed in accordance with the current Building Code of Australia, the current Australian Standards and all relevant current trade & technical manuals

Stormwater / Drainage Notes

- Drainage to be in accordance with part 3 of the BCA. Point to meet local authority requirements
- All plumbing & draining is to comply with the standard sewerage by-laws & requirements of the local authority
- All downpipes to be installed in accordance the current Building Code of Australia 3.5.2.5, each downpipe must not serve more than 12m of gutter length
- $\bullet \ \, \text{Stormwater system to local authority requirements (owner/applicant/builder to ensure no storm water runoff occurs onto adjoining properties, back onto any structures \& no ponding under sub floor areas$
- Stormwater approval for legal discharge to be obtained from local authority prior to work commencing.
 Discharge is proposed to: kerb & channel, rubble pit to council requirements, inter allotment drainage, storm water service main, canal or river.

Energy	Efficiency

To comply with BCA 3.12 (unless otherwise stated)

AS PER ENERGY RATING ASSESSMENT CERTIFICATE

Construction Notes

This building has been designed in accordance with the current building code of australia, building act ammendment & australian standards

Roofing	Colorbond sheet, Pitch as specified on drawings
Ceiling Height	As specified on drawings
Joinery Level	As specified on drawings
Footings	To engineers design & detail
Slab Height	To engineers design & detail
Termite Management	In accordance with BCA volume 2, 3.1.3 termite risk management and A.S. 3660.1/1995
External Walls - Brick Veneer	230mm - 110mm Brickwork, 50mm Cavity, 70mm Timber Studs
External Walls - Lightweight	70mm Timber stud - lightweight cladding as per plans
Internal Linings	10mm Plasterboard; 6 mm Villaboard to all wet areas
Ceiling Linings	10mm Plasterboard
Soffit Linings	4.5mm Hardiflex
Window Flashing	To All Windows. As per manufacturers details
Roof Bracing	Speed Brace. As per manufacturers details
Fascia	Metal Fascia Fixed To Standard Rafter Bracket, Complete With Mitre Angles, Joining Sleeves Etc
Downpipes	PVC
Guttering	Colorbond
Smoke Alarms	To Be Hard Wire Installed In Accordance With Part 3.7.2 Of The B.C.A.

Timber Schedule

Wall Framing

Ton Plate

Note: all timber sizes are based on the current timber engineering code AS 1720. All member types are analyzed using limit state principles incorporatings the latest timber technology available. All of the member types accessible using timber sizes meet the loading and serviceability criteria outlined in AS 1170.1 saa loading code and as 1684.2 - 2010 - residential timber-framed construction - part 1 - design criteria. All timber framing to be in accordance with AS 1684.3-2010

Seasoned Pine

(Load Bearing)	2 / 35 X 70 (MGP 12)			
Bottom Plate (Load Bearing)	35 X 70 (MGP 12)			
Bottom Plate (Non Load Bearing)	35 X 70 (MGP 10)			
Studs (Load Bearing)	35 X 70 (MGP 12) @ 450 cts.			
Studs (Non Load Bearing)	35 X 70 (MGP 10) @ 600 cts. (max. height 3000mm)			
Nogging:	35 X 70 (MGP 10)			
Jam studs:	Beside open. up to 1400mm wide 2 / 35 X 70 (MGP 12)			
	Beside open. up to 2300mm wide 3 / 35 X 70 (MGP 12)			
	Beside open. up to 3300mm wide 4 / 35 X 70 (MGP 12)			
1	refabricated timber roof trusses @ specified 600 cts. russes to be engineer designed & fixed in accordance with nanufacturer's specifications & tie down details			
Lintels & beams: As specified by engineer designed & fixed in accordance with manufacturer's specifications & tie down details				
	specified by engineer designed & fixed in accordance th manufacturer's specifications & tie down details			

Articulation Joints

- (a) Verticle articulations joints must be provided in unreinforced masonry walls except where the site soli classification is A or S
 b) Articulation joints between masonry elements must have a width not less than 10 mm and be provided (see **Figures 3.3.1.7**and **3.3.1.8**)-
 - (i) in straight, continuous walls having no openings, at not more than 6 m centres and not closer than the height of the wall away from corners; and
 - (ii) where the height of the wall changes by more than 20%, at the position of change in height; and
 - iii) where openings more than 900x900 mm occur, at not more than 5 m centres, and positioned in line with one edge of the opening; and
 - (iv) where walls change in thickness; and
 - (v) at control or construction joints in footing slabs; and
 - (vi) at junctions of walls constructed of different masonry materials; and
 - (vii) at deep chases (rebates) for service pipes.
- For all articulation joints in cavity walls, extendable masonry anchors must be built in at every fourth course (see **Figure 3.3.1.9**). For veneer construction the extendable ties may be omitted.
- d) For single leaf masonry walls stabilised by return walls, or engaged piers, any articulation joints must be within 300 mm of the vertical support (see **Figures 3.3.1.3** and **3.3.1.4(b)**).
- Where masonry is required to be waterproof all joints must be sealed with a flexible, compressible material (see **Figure 3.3.1.9**).
- f) Articulation joints must not be constructed adjacent to arched openings.
- (g) Articulation joints must not be located in unreinforced masonry above garage door openings or the like unless the panel of masonry is laterally supported with masonry ties or other suitable means.

DEVELOPMENT NEAR UNDERGROUND UTILITY SERVICES

For the purpose of this section of the table:

- An approval that has been granted to the development pursuant to Section 823 of the Water Act 2000 is deemed to satisfy the Performance Criteria of this section.⁴
- "Access Cover" means a removable cover to provide access for cleaning or inspection of sewers, stormwater drains and water mains.
- "Associated Structure" includes a sewer or stormwater manhole, a water meter and a fire hydrant.
- · "Building" has the meaning defined in the Building Act 1975.
 - "Connection Point" has the meaning defined in the Standard Sewerage Law.
 - "Invert Level" means the bottom level of the inside of the pipe or drain.
- "Manhole" means an access chamber being a below Ground Level structure, with a cover, built in the line of a sewer or stormwater drain, through which a person may access the sewer or stormwater drain.
- *Sewer" includes sanitary drain jump-ups and capped slope junctions and manholes.
- "Structure' includes a masonry fence, deck, pergola, satellite dish, water storage tank and a retaining wall (of greater than 1 metre in Height).
 - "Zone of Influence" means the area shown on the following diagram:

<u>Legend</u>		and	WMS	Washing Machine Space
		<u>iiu</u>	W.I.R	Walk-in-Robe
			SGD	Sliding Glass Door
	BCA	Building Code of Australia	SW	Aluminum Sliding Window
	AS	Australian Standards	DH	Aluminum Double Hung Window
	DP	Downpipe	AW	Aluminum Awning Window
	HWS	Hot Water System	LV	Aluminum Louvre Window
	SHS	Steel Post	FG	Fixed Glass
	SD	Service Duct	SL	Side Light
	FW	Floor Waste	SHR	Shower
	T.B.C	To Be Confirmed	TR	Towel Rail
	R.L	Relative Level	TRH	Toilet Roll Holder
	AFL	Above Floor Level	VSD	Vinyl Sliding Door
	NGL	Natural Ground Level	MSD	Mirrored Sliding Door
	FGL	Finished Ground Level	CSD	Cavity Sliding Door
	OHC	Overhead Cupboard	RW	Rainwater Line
	UBO	Under Bench Oven	DW	Dishwasher Provision
	WO	Wall Oven	MO	Microwave Provision

Area Catcutations			
House:	171.24 sqr		
Garage:	36.06 sqr		
Porch:	2.45 sqr		
Alfresco:	10.90 sqr		
Total:	220.65 sq		

Area Calculations



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Please Read Carefully

Owner / s

....Date...

Freedom Developments


Lot 162 Davidson Circuit, Park Ridge (Carvers Reach Estate)

		10tat.		220.05 30	1
	Plot Date: 9/02/21	Drawing No:	Issue:	Scale:	1
Legends / Notes	Job Nº:	2 of 13	В	Designed By:	Ī
Design Name:	\Maukina	Drawina	_	Drawn By:	(
Hamilton	vvorking	Drawing	5	Checked By:	_




Site Notes:

- final length & position of all retaining walls t.b.c on site by supervisor
- retaining walls higher than 1m in height to be engineered designed
- retaining walls constructed from treated pine timber, masonry blockwork or rock as per plans
- retaining walls may change location at supervisor's discrection if required
- fencing in accordance with developer covenants
- driveway gradient not to exceed 1:5
- Batters to comply appropriate soil classification described in table 3.1.1.1.BCA Vol.2.
- stormwater to legal point of discharge

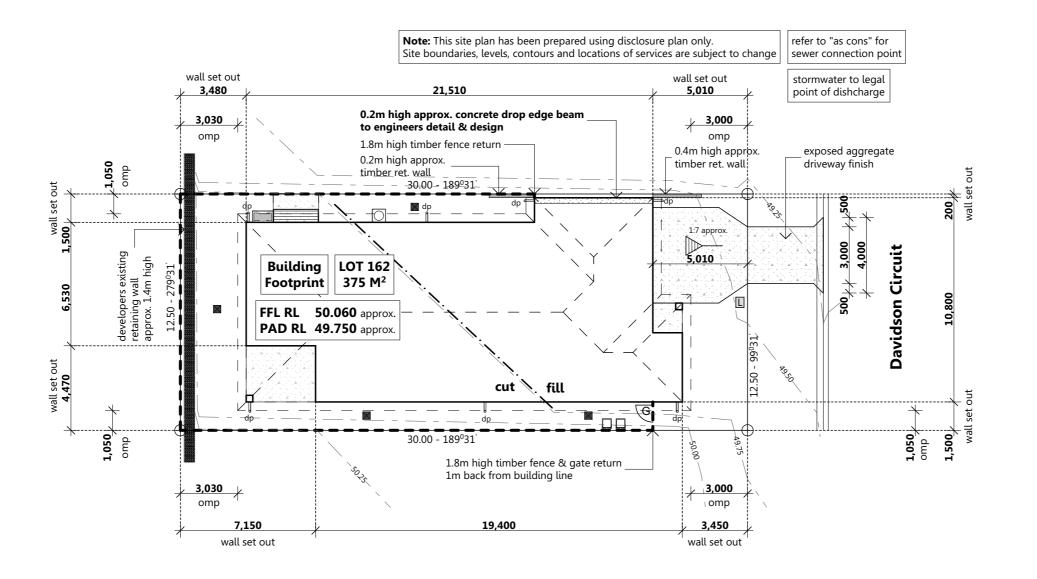

Legend

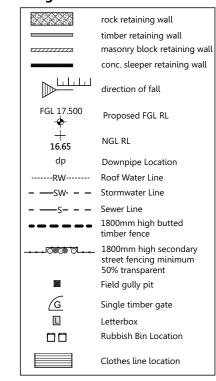

Real Property Description

Lot Number: 162

Registered Plan Number: SP

Parish:

County:

Local Authority: Logan C.C

Site Area: 375M² Site Coverage: 58.84%

Driveway Gradient						
Grade	1:7 approx.					
Transitional	Grade	1:8	1:4	1:8		
Transitional	Distance	n/a	n/a	n/a		
FFL	R.L 50.060	R.L 50.060				
NGL (boundary)	R.L 49.375					
Height Gain	0.685 m	0.685 m				
Distance	5.01 m					

	Area Calculations			
	House:	171.24 sqm		
	Garage:	36.06 sqm		
	Porch:	2.45 sqm		
	Alfresco:	10.90 sqm		
	Total:	220.65 sqm		
_				



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Freedom Developments Lot 162 Davidson Circuit, Park Ridge

(Carvers Reach Estate)

Plot Date: 9/02/21 Drawing No: Site Plan Design Name: **Working Drawings** Hamilton

Checked By: MB

Note: · Lift off hinges to wc door Provide gpo & cold water tap provisions to d/w space • Electric HWS Mechanically vent rooms without natural ventilation • All shower roses to be AAA rated Water pressure limited to 500KPa at the meter · All ground drains to be > 1000mm from gas bottle location Nogging to be positioned where indicated in bathroom at 1100 afl for fixing of towel rail (TR) Handrail to be fixed to one side of all stairways (1000mm or higher only) Water connection to fridge space at 1900mm afl Elevations · Opening windows in bedrooms with fall height of 2m or greater to be restricted 23,970 to max. 125mm opening (Sliding windows with keyed vent locks; overall awning with ratchet restriction) 450 eaves 23,070 eaves 15,250 6,260 breaks breaks 530 70 µ,70 µ, 1,000 µ,70 1,900 70 µ, 2,930 5,800 230 / / 1,210 / /350 230 230 1,960 70 y 1,650 70 y 1,000 y 70 20mm Stone Benchtops eav to kitchen and bathrooms w/m space under drop in tub, c'boards under wall mount slimline ducted a/c external unit as per build spec. 820 (HWS) OBS 1212 XO SW 1218 XO SW 2115 XO SGD 1,930 Garage Bed 3 Bed 2 L'dry Activity 1,000 170 Bath plain conc. carpet • 820 820 6,530 1,000 170 sill @ 1200 820 W.I.L tiles m/h | W.I.P <u>| 1,200 | </u> Nook tiles 820 /720 1,000 % Bed 4 1,430 70 1,000 approx. Porch 90mm stud to this wall -1,930 a/c unit Entry exp. agg. location 820 tiles / 230 / / 1,300 \ 840 \ W.I.R carpet Kit Living Dining 720 Bed 1 Media carpet **③** Alfresco 2,620 carpet exp. agg. Ens. heated 23044 230+ ___ O<u>BS</u> 600mm wide electric cooktop, ___dp ubo & slide-our r/hood dp __ 0404 tiled shower niche eaves $\langle A \rangle$ 6,500 70 1 2,140 230 230 3,320 9,000 breaks breaks 23,070 eaves eaves 23,970 overall



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Freedom Developments

Lot 162 Davidson Circuit, Park Ridge (Carvers Reach Estate)

 Title:
 Plot Date: 9/02/21
 Drawing No: Job N°:
 Issue: Job No: Drawing No: Job N°.
 Issue: Job No: Job No: Job No: MB
 Scale: 1:100 @ A3
 MB

 Design Name: Hamilton
 Working Drawings
 Drawin By: CN (Checked By: MB)

3,660

Area Calculations


171.24 sqm 36.06 sqm

2.45 sqm 10.90 sqm


House:

Garage: Porch:

Alfresco:

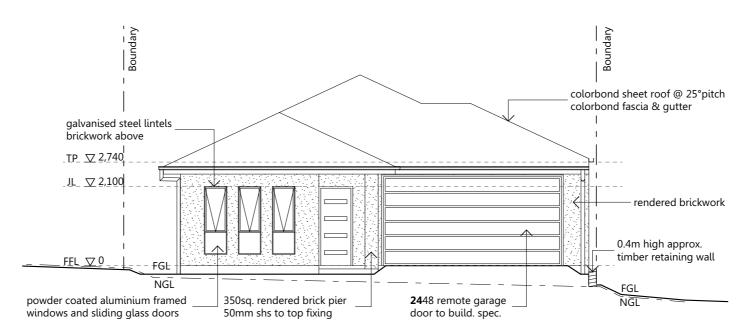

Elevation 1

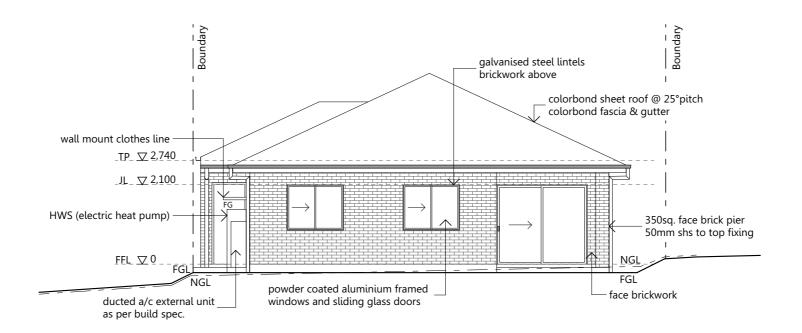

Elevation 2

Note: • These plans are to be read in conjunction with builders detailed specifications & all engineering documentation. • Articulation joints as per engineering details • All opening windows with fall height of 2m or greater to be restricted to max. 125mm opening

 House:
 171.24 sqm

 Garage:
 36.06 sqm

 Porch:
 2.45 sqm

 Alfresco:
 10.90 sqm

 Total:
 220.65 sqm

Area Calculations



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Freedom Developments
Lot 162 Davidson Circuit, Park Ridge

(Carvers Reach Estate)

Title:

Plot Date: 9/02/21

Job No:

Plot Date: 9/02/21

Job No:

Title:

Plot Date: 9/02/21

Job No:

Title:

Plot Date: 9/02/21

Job No:

Title:

Plot Date: 9/02/21

Job No:

Torwing No:

Scale: 1:100 @ A3


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Designed By: MB


Drawings:

CN


Checked By: MB

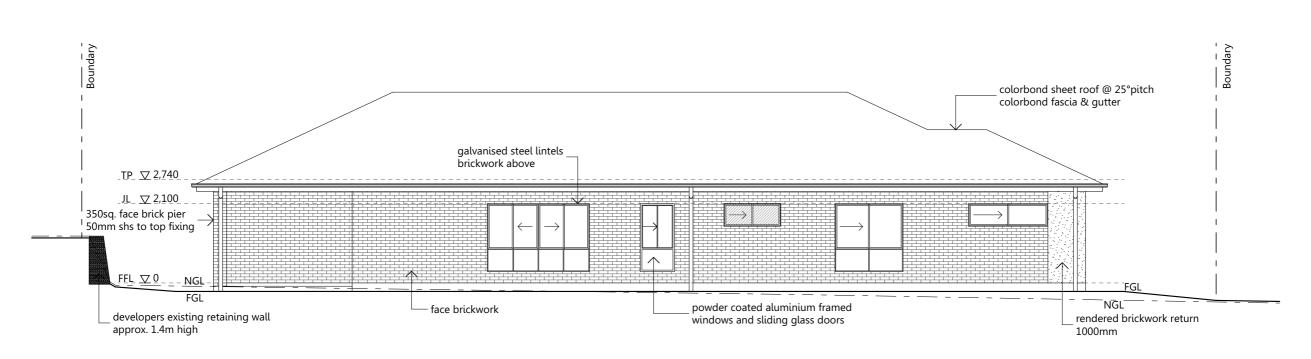

Elevation 3

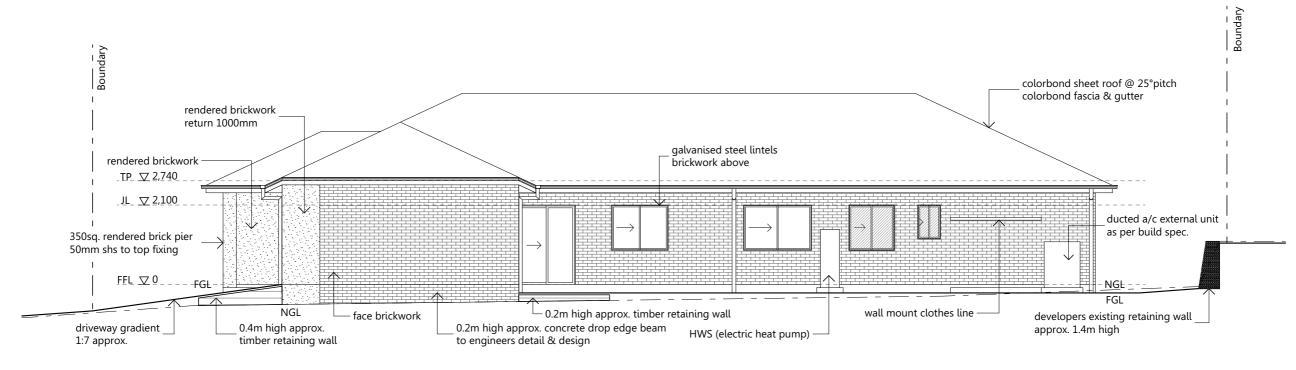

Elevation 4

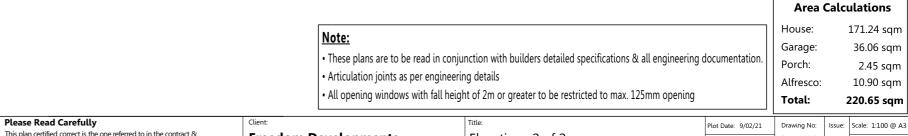




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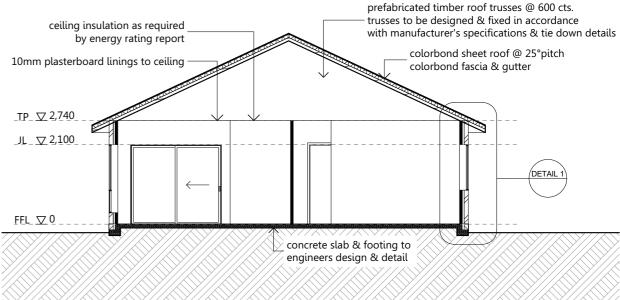
Freedom Developments

Lot 162 Davidson Circuit, Park Ridge (Carvers Reach Estate)

Title:

Plot Date: 9/02/21	Drawing No:	Issue:	Scale: 1:100 @ A3			
Elevations 2 of 2		Job No:	6 of 13	B	Designed By:	MB
Design Name:	Working Drawings	CN	Checked By:	MB		



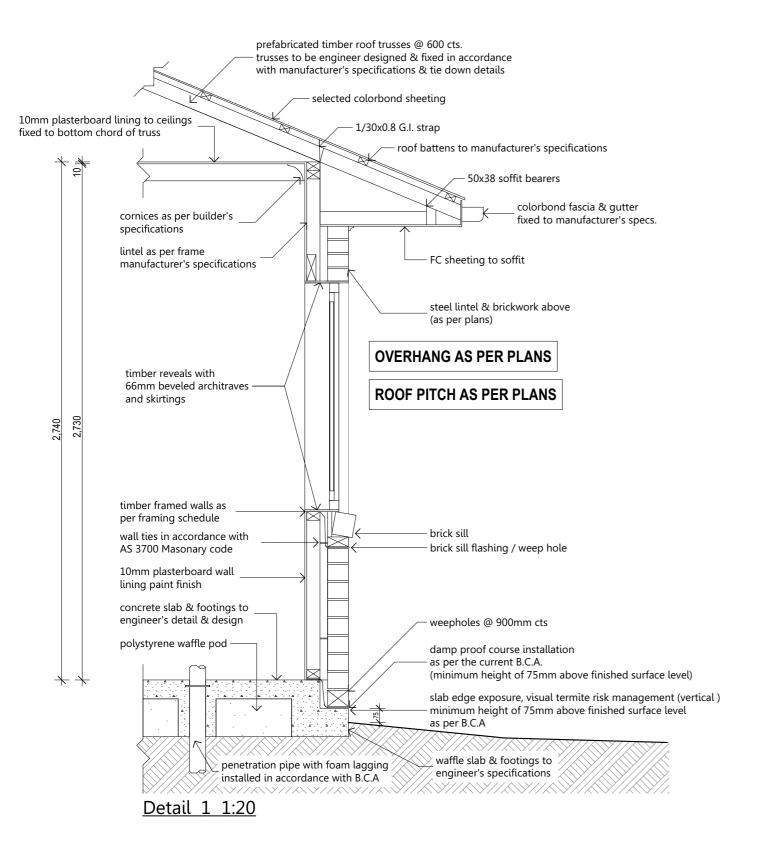

Section A 1:100 @ A3

Area Calculations House: 171.24 sqm Garage: 36.06 sqm Porch: 2.45 sqm 10.90 sqm Alfresco: Total: 220.65 sqm



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...Date...

Freedom Developments Lot 162 Davidson Circuit, Park Ridge

(Carvers Reach Estate)

Plot Date: 9/02/21 Issue: Scale: as per dw Drawing No: Sections / Details 7 of 13 **B** Design Name: **Working Drawings** Hamilton Checked By: MB

Legend

Under Slab Points

fw Floor Waste

tw Toilet Waste vw Vanity Waste

sw Shower Waste

bw Bath Wasteksw Kitchen Sink Wasteltw L'dry Tub Waste


pd Plumbing Duct Waste lbw Load Bearing Wall

Notes:

- This slab plan is to be read in conjunction with engineers documentation
- Internal load bearing walls as per engineers or

frame manufacturers design



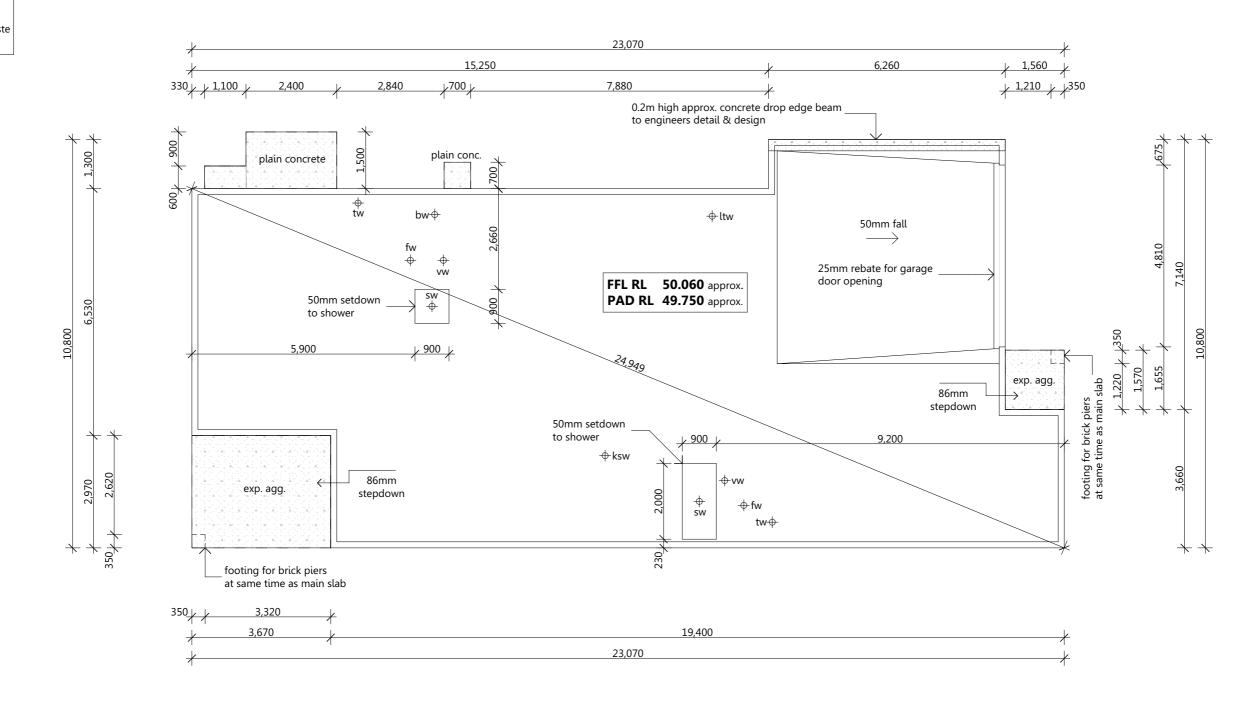

Area Ca	accutations
House:	171.24 sqr
Garage:	36.06 sqr
Porch:	2.45 sqr
Alfresco:	10.90 sqr
Total:	220.65 sq



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Freedom Developments

Lot 162 Davidson Circuit, Park Ridge
(Carvers Reach Estate)

Title:

Plot Date: 9/02/21	Drawing No:	Issue:	Scale: 1:100 @ A3		
Slab Layout	Job N°:	8 of 13	8	Designed By:	MB
Design Name:	Working Drawings	CN	Checked By:	MB	

Electrical Legend

Electrical Legend					
Symbol	D	escriptio	n		
wp	Double power outlet (water proof)				
wp	Single pow	er outlet (w	vater proof)		
<u></u>	Single pow	er outlet			
*	Double pov	wer outlet			
0	Down light	point - 18	w (CFL)		
•	Down light	point - 18	w (LED)		
•	Feature dov	wnlight poi	int - 18w (Haloge	n or LED)	
Ю	Round Oys	ter Fluro Li	ght Point - 36w		
₩	Feature Per	ndant light	point - 18w		
\forall	Exterior wa	ll mount lig	ght point - 36w		
#	Feature ext	erior up &	down light point -	- 36w	
\vdash	Single fluor	rescent ligh	nt point - 36w		
Ш	Double fluc	orescent lig	ht point - 36w		
D	Stairwell 1/	'2 oyster wa	all light point - 18	w	
0	Exhaust Fan on separate switch control vented into ceiling space or externally				
\rightarrow		Exhaust Fan on light switch control vented into ceiling space or externally			
:::	Fan / Light / Heater (4 Globe)				
₩	Fan / Light	/ Heater (2	Globe)		
•	Smoke dete	ector - to b	e interconnected	& h/wired	
—	Data point				
■	Phone poin	nt			
н	T.V Point				
	Ceiling fan				
	Ceiling fan / light				
a/c int.	Air Condition	oner - Inter	nal Unit		
a/c ext.	Air Condition	oner - Exte	rnal Unit		
	Zoned Duc	ted Vent -	Air Conditioner		
Heights		⊕ 1150 AEI	D-frigorator	@ 1500 AEI	
Light Switches Wall Mounted L	iahts	@ 1150 AFL @ 2000 AFL	Refrigerator Rangehood	@ 1500 AFL @ 1800 AFL	
Power Outlets (@ 300 AFL	Dishwasher	@ 300 AFL	
Microwave Ove	n (Oven Tower) n (Under Bench)	@ 1800 AFL @ 700 AFL	Vanity Basins Laundry Bench	@ 1050 AFL @ 1050 AFL	
Kitchen Bench	,				

Smoke alarms in the dwelling must:

- i) be photoelectric (AS 3786-2014); and
 - ii) not contain an ionisation sensor; and
 - iii) be hardwired to the mains power supply with a secondary power source (i.e. battery); and
 - iv) be interconnected with every other smoke alarm in the dwelling so all activate together.


Smoke alarms must be installed on each storey:

- i) in each bedroom; and
- ii) in hallways which connect bedrooms and the rest of the dwelling; or
- iii) if there is no hallway, between the bedrooms and other parts of the storey; and
- iv) if there are no bedrooms on a storey at least one smoke alarm must be installed in the most likely path of travel to exit the dwelling.

Zoned Ducted Air Conditioning

- refer to builders specifications for unit type
- location of vents as per manufacturer's recommendations
- zone settings as per manufacturer's recommendations
- location of wall mount control panel as per installers recommendations
 to be installed as per manufacturer's specifications



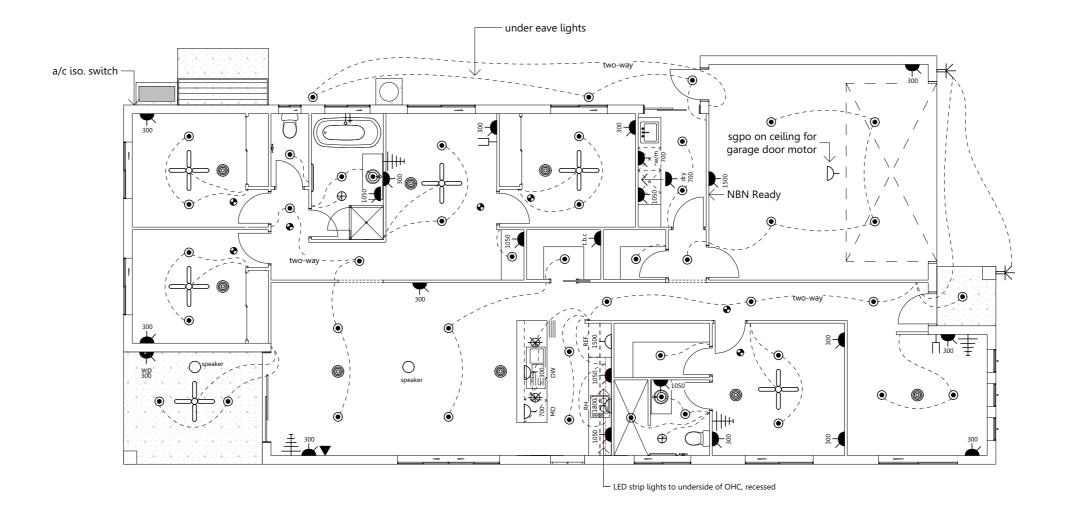

Area Ca	lculations
House:	171.24 sq
Garage:	36.06 sq
Porch:	2.45 sq
Alfresco:	10.90 sq
Total:	220.65 sq



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...Date..

Freedom Developments

Lot 162 Davidson Circuit, Park Ridge (Carvers Reach Estate)

		TOLAL:		220.65 80	ļm
Title:	Plot Date: 9/02/21	Drawing No:	Issue:	Scale: 1:100 (@ A3
Electrical Plan	Job Nº:	9 of 13	В	Designed By:	МВ
Design Name:	Warking	Drowing	_	Drawn By:	CN
Hamilton	Working	Drawing	5	Checked By:	МВ

Bracing Notes

BRACING TYPES USED: Type (h) Method B - Plywood

- -Minimum length of panels may be 600mm
 -Plywood shall be fixed to frame in a/w AS1684.2 using 30 x 2.8mm diam. galvanized flathead nails or equivalent
 -Fastener spacing; top and bottom plate 150mm, vertical edges 150mm, intermediate studs 300mm
- -Bracing capacity of Type (h) Method B is 6.0kN/m
- Type (d) Metal angle brace
- -Maximum depth of notch shall not exceed 20mm -Length of bracing 1800mm min. to 2700mm max.
- -Bracing capacity of Type (d) is 3.0kN/m
- -Metal angle of min. nominal section of 18 x 16 x 1.2mm must be fixed to frame in a/w AS1684.2 -2/30 x 2.8mm diam. nails to each stud
- -30×0.8 mm galv. strap $3/30 \times 2.8$ mm diam. galv. flathead (or equivalent) nails to each end to stud

STRUCTURAL BRACING:

- -For wall heights greater than 2700mm the bracing capacity of bracing walls is reduced and must
- be recalculated using the values given in Table 8.1.9 of AS1684.2/AS1684.3.
 -Bracing shall initially be placed in external walls and where possible at the corners of the building. Remaining bracing shall be evenly distributed throughout building.
- -Bracing shall not be placed on external walls under the eaves unless suitable connections to the main ceiling diaphragms are provided.
- -The maximum distance between braced walls at right angles to the building length/width shall not exceed 9000mm for wind classification N2. For wind classification greater than N2 spacing shall be in accordance with Table 8.20 and 8.21 in AS1684.2./AS1864.3.
- -All internal bracing walls shall be fixed to the floor, ceiling and/or external wall frame with $\,$ structural connections of equivalent shear capacity to the bracing capacity of that particular bracing

ROOF TRUSSES and ROOF BRACING:

-To be designed by truss manufacturer to comply with AS1684.2, AS1720 and AS4440.

TEMPORARY BRACING NOTES:

- -The builder is to ensure that the building is adequately braced during construction.
- -Temporary bracing shall be equivalent to at least 60% of the permanent bracing required.
- Temporary bracing may form part of the installed permanent bracing.

NOMINAL WALL BRACING:

- -Nominal bracing, wall frames lined with sheet material such as plywood, plasterboard or fibre
- cement, may provide up to 50% resistance of the total racking forces. -Wall frames must be nominally fixed to the floor and roof frame.
- -Nominal bracing shall be evenly distributed throughout the building.

- -Minimum length of nominal bracing walls shall be 450mm.
 -Sheeted one side only: Bracing capacity 0.45kN/m
 -Sheeted two sides: Bracing capacity 0.75kN/m
 -1/75mm masonry nail, screw or bolt @1200 crs max.

Tie-Down Schedule


-Nominal fixings to all timber members in accordance with relevant standards; AS1684.2, AS1684.3 M12 Cyclone rods to either side of external openings over 1800mm wide and at 1800mm max. centres N1, N2, N3 Sheet roofing


M12 Cyclone rods to either side of external openings over 2400mm wide N1, N2, N3 Con. tile roofing

BATTENS / TRUSSES

- -1/No 14 Type 17 x 75mm screws, or as per truss manufacturer's specifications \mbox{TRUSS} / $\mbox{TOP PLATE}$
- -1/30 x 0.8mm G.I. strap over each truss, 4/2.8mm diam. nails each end
- -Girder truss to have 2/30 x 0.8mm G.I. straps, 4/2.8mm diam nails each end
- LINTEL / TOP PLATE
- -30 X 0.8mm looped strap @900 crs max, 4 nails each end LINTEL / JAMB STUD
 -30 x 0.8mm G.I. strap @900 crs max, 4/2.8mm diam. nails each end
- **BOTTOM PLATE / CONCRETE SLAB** -1/75mm masonry nail, screw or bolt @1200 crs max.



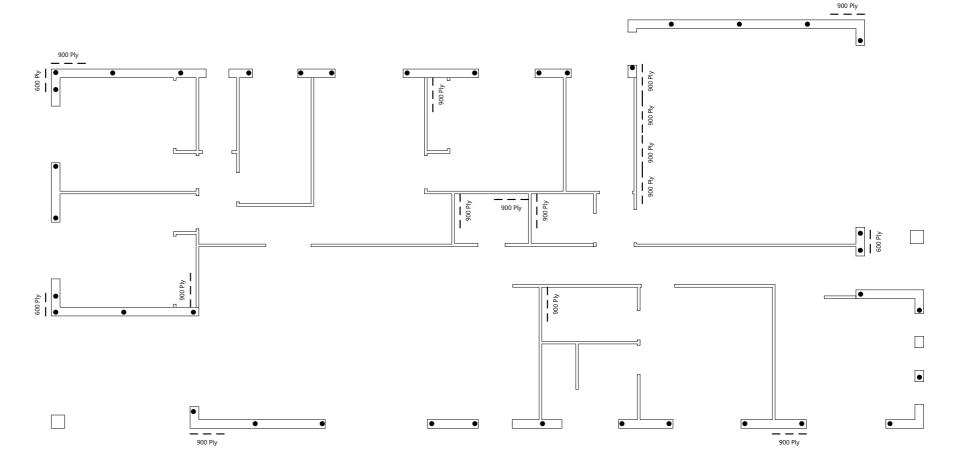

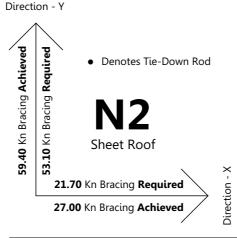

Direction)	(N2 :	Sheet	Roof
Туре	Length	Resistance	Qty.	Total (kN)
Ply Brace	600	6.0 kN/lm		
Ply Brace	900	6.0 kN/lm	05	27.00
Metal Strapping (Double Cross)	2000	3.0 kN/lm		
Total	Resistan	ce Achieved		27.00

Direction \	1	N2	Sheet	Roof
Туре	Length	Resistance	Qty.	Total (kN)
Ply Brace	600	6.0 kN/lm	03	10.80
Ply Brace	900	6.0 kN/lm	09	48.60
Metal Strapping (Double Cross)	2000	3.0 kN/lm		
Total	Resistan	ce Achieved		59.40

 M12 Cyclone rods to either side of external openings over 1800mm wide And at 1800mm max. centres N1, N2, N3 Sheet roofing

Total:	220.65 sqm
Alfresco:	10.90 sqm
Porch:	2.45 sqm
Garage:	36.06 sqm
House:	171.24 sqm

Area Calculations



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Please Read Carefully

Owner / s ...

This plan certified correct is the one referred to in the contract & specifications and I understand change hereafter may not be possible. These plans supercede all other previous plans or sketches. Owner / s

...Date..

Freedom Developments Lot 162 Davidson Circuit, Park Ridge

(Carvers Reach Estate)

		l otal:		220.65 sc	ĮΠ
	Plot Date: 9/02/21	Drawing No:	Issue:	Scale: 1:100 (@ .
Bracing Plan	Job Nº:	10 of 13	В	Designed By:	N
Design Name:	Warking	Drowing		Drawn By:	C
Hamilton	Working	Drawing	5	Checked By:	M



Landscaping / Planting Legend

2D Plant Symbol		**	8	0	•
Name	Waterhousia Floribunda	Syzguim Australe	Lxora Coccinea	Liriope "Evergreen Giant"	Dietes Bicolor
Pot Size	45l	200ml	200ml	140ml	140ml
Width	3.5m	1.5-2.0m	2.0m	0.8m	1.0m
Height	8m	0.5-1.0m	0.5-1.0m	0.6m	0.8m

All plant species & quantities are indicative and subject to availability and suitability to site. Should a particular nominated plant not be available an equilayant replacement shall be used

Legend

_	
	exposed aggregate
***	river pebbles (20 - 40mm, weed mat under
* * * * * * * * * * * * * * * * * * *	'A' grade turf
	garden edging

refer to "as cons" for sewer connection point

Site Notes:

final length & position of all retaining walls t.b.c on site by supervisor
retaining walls higher than 1m in height to be engineered designed

• fencing in accordance with developer covenants


driveway gradient not to exceed 1:5

• stormwater to legal point of discharge


• retaining walls may change location at supervisor's discrection if required

• retaining walls constructed from treated pine timber, masonry blockwork or rock as per plans

stormwater to legal point of dishcharge

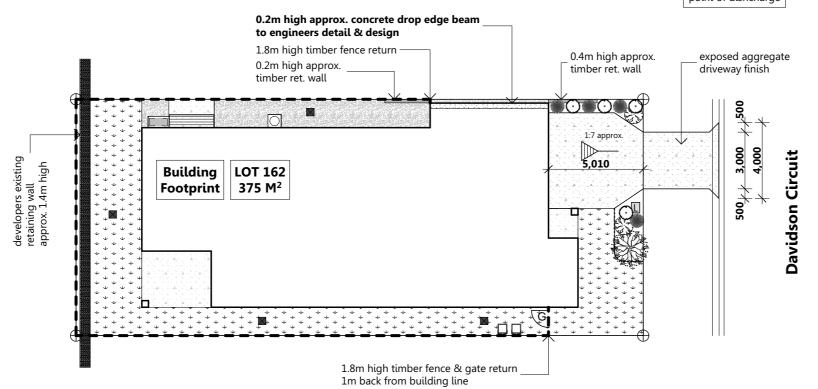

• Batters to comply appropriate soil classification described in table 3.1.1.1.BCA Vol.2.

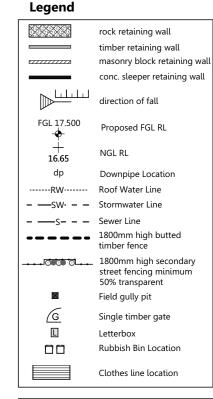

Real Property Description

Lot Number: 162

Registered Plan Number: SP

Parish:

County:

Local Authority: Logan C.C

Site Area: 375M² Site Coverage: 58.84%

Driveway Gradient				
Grade 1:7 approx				
Transitional	Grade	1:8	1:4	1:8
Transitional	Distance	n/a	n/a	n/a
FFL	R.L 50.060			
NGL (boundary)	R.L 49.375	5		
Height Gain	0.685 m			
Distance	5.01 m			

Area (Calculations
House:	171.24 sqm
Garage:	36.06 sqm
Porch:	2.45 sqm
Alfresco:	10.90 sqm
Total:	220.65 sqm



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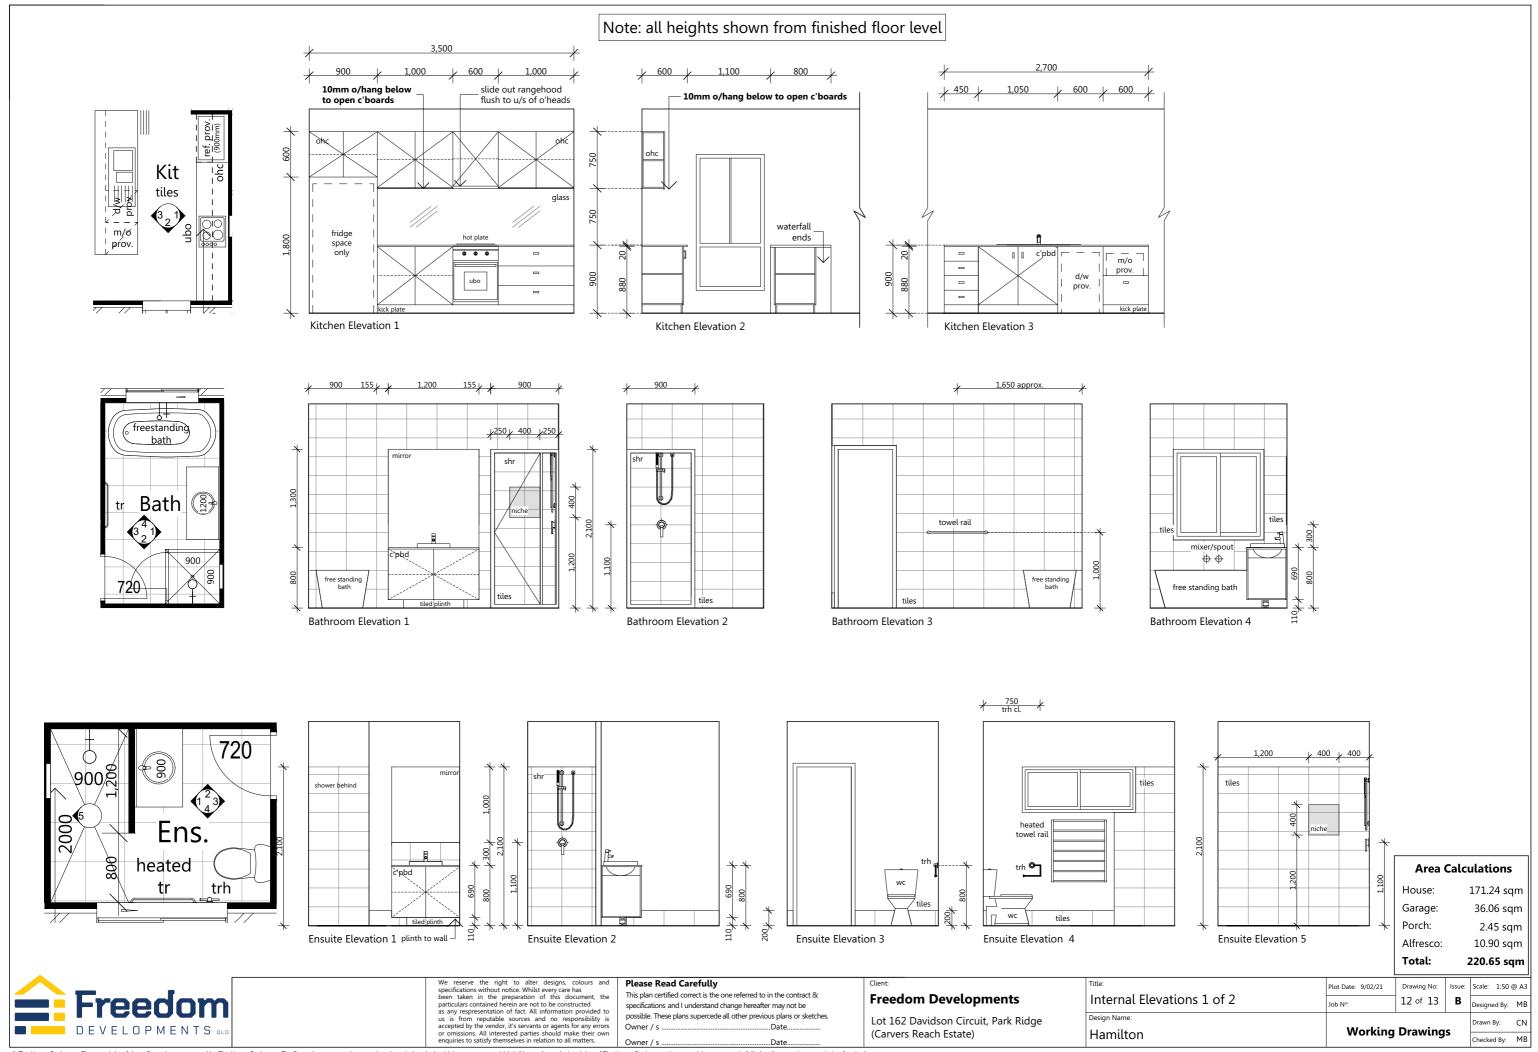
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....Date....


Freedom Developments


Lot 162 Davidson Circuit, Park Ridge (Carvers Reach Estate)

		Total:		220.65 sc	ļΜ
	Plot Date: 9/02/21	Drawing No:	Issue:	Scale: 1:200 (@ A:
Landscaping Plan	Job Nº:	11 of 13	В	Designed By:	ME
Design Name:	Warkin -	Dunamina	_	Drawn By:	CN
Hamilton	Working	Drawing	s 	Checked By:	ME





Note: all heights shown from finished floor level y 600 y 350 y → 750 → trh cl. →

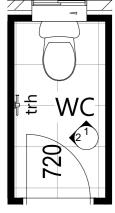


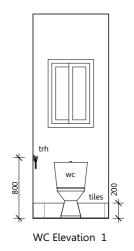



<u> 450</u> <u> 1,060</u> <u> 450</u> <u> 1</u>

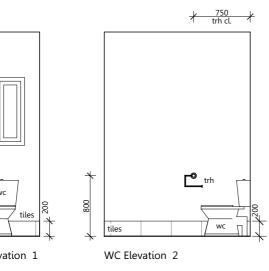


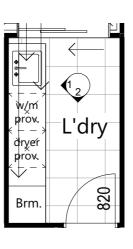


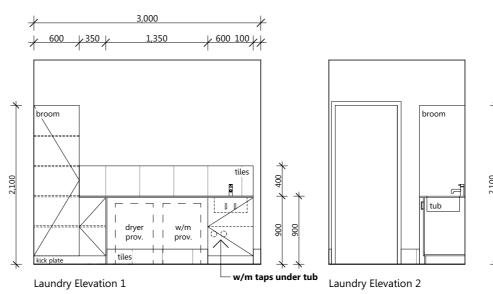


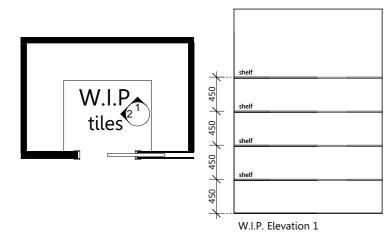


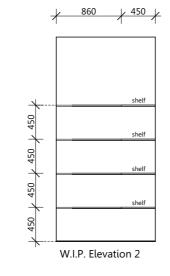


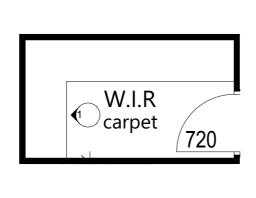

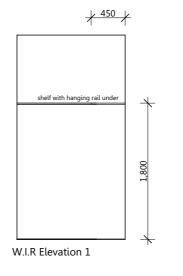

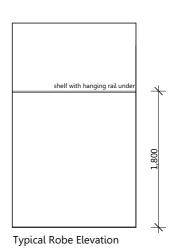

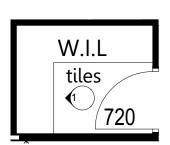

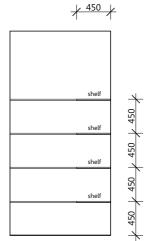

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Client:
Freed

Freedom Developments Lot 162 Davidson Circuit, Park Ridge

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l	

Area Calculations



(Carvers Reach Estate)

Drawing No: Internal Elevations 2 of 2 13 of 13 **B** Design Name: **Working Drawings** Hamilton