

Level Datum:	A.H.D. vide PSM 30887	<u> </u>
Bench Mark	Berry Street	] :
Location:		Ι.
Adopted Level:	18.632m AHD	1
Contour Interval:	0.5 metres	1:
©	A3 SHEET AT SCALE	٦,

ne areas and distances on this plan re approximate only and are subject Local Authority approval and final urvey.

survey.
The contours and levels on this plan are for subdivisional design purposes only and should not be used for any other purpose.

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SURVEYED:
DRAWN: S.P.B.
CREATED: 28/08/2012
SCALE: 1:600
APPROVED:

DIRECTOR Date

PROPOSED RECONFIGURATION OF A LOT (6 INTO 6 LOTS & NEW ROAD)

Of Lots 38 — 41 on RP30068
and Lots 9 & 101 on SP127089
(Berry Street & Phoenix Court, Churchill)
Parish of PURGA County of Churchill



77 RODERICK STREET
IPSWICH Q. 4305
PH 3812 2076 FAX 3812 1614
survey@bairdandhayes.com.au (Survey)
planning@bairdandhayes.com.au (Planning)

REF NO. 9597


DWG. NO. Rev. P32-01a



PROPOSED NEW ROAD WATER MAIN EX. OVERHEAD POWER EX. SEWER PIPE PROPOSED SEWER DRAIN INVERT CADASTRAL BOLINDARY PROPOSED CONTOURS 0.5m PROPOSED CONTOURS 0.25m EX. CONTOUR 1m — vz —— vz — STORMWATER PIPE EX. ROOFWATER PIPE EX. UNDERGROUND TELSTRA CROWN OF ROAD NOTE:

- (1) THIS PLAN WAS PREPARED FOR THE PURPOSE AND EXCLUSIVE USE OF RANDS DEVELOPMENT NO.2 PTY. LTD.
  TO BE USED FOR ENGINEERING DESIGN PURPOSES. THIS PLAN IS NOT TO BE USED WITHOUT THE SUPPLIED DIGITAL INFORMATION. THIS INFORMATION IS NOT TO BE USED FOR ANY OTHER PURPOSE OR BY ANY
- OTHER PERSON OR CORPORATION.

  REQUESTS MADE TO BAILD & HAYES FOR THE SUPPLY OF ADDITIONAL DIGITAL AND/OR HARD COPIES IS TO BE MADE IN WRITING BY THE PERSON OR CORPORATION FOR WHICH THIS PLAN WAS PREPARED. BAIRD & HAYES CONSULTING SURVEYORS ACCEPT NO RESPONSIBILITY FOR ANY LOSS OR DAMAGE SUFFERED HOWSOEVER ARISING TO ANY PERSON OR CORPORATION WHO MAY USE OR RELY ON THIS PLAN IN CONTRAVENTION OF THE TERMS OF THIS CLAUSE OR CLAUSES (2),(3)
- (2) THE CONTOURS AND LEVELS SHOWN ON THIS PLAN ARE SUITABLE ONLY FOR THE PURPOSE FOR WHICH THIS PLAN WAS PREPARED AND SHOULD NOT BE USED FOR ANY OTHER PURPOSE.
- (3) THE TITLE BOUNDARIES SHOWN HEREON WERE NOT MARKED AT THE TIME OF SURVEY AND HAVE BEEN DETERMINED BY PLAN DIMENSION ONLY, AND NOT BY FIELD SURVEY. THE SERVICES HEREON HAVE BEEN LOCATED WHERE POSSIBLE BY FIELD SURVEY. IF NOT ABLE TO BE LOCATED, SERVICES MAY BE PLOTTED FROM RELEVANT AUTHORITY RECORDS AND HAVE BEEN NOTED ACCORDINGLY ON THIS PLAN. PRIOR TO ANY DEMOLITION, EXCAVATION OR CONSTRUCTION ON THE SITE, THE RELEVANT AUTHORITY SHOULD BE CONTACTED FOR POSSIBLE LOCATION OF FURTHER UNDERGROUND SERVICES AND DETAILED LOCATIONS OF ALL SERVICES.
- (4) THIS PLAN MAY NOT BE COPIED UNLESS THIS NOTE IS INCLUDED. <THIS PLAN IS COPYRIGHT>

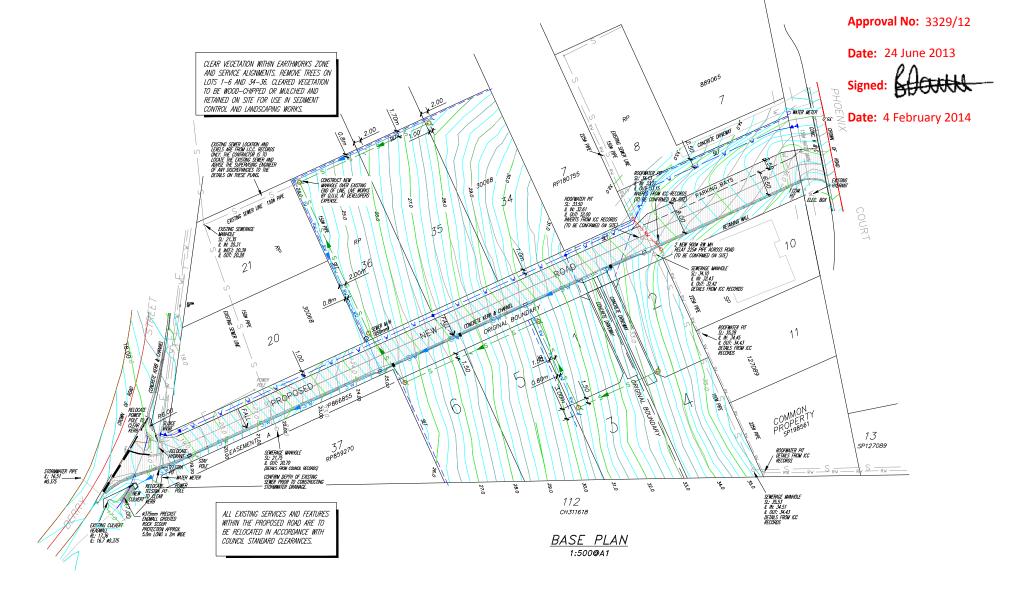



#### GENERAL NOTES

- 1. ALL WORK SHALL BE JOINED NEATLY TO EXISTING CONSTRUCTION.
- CONSTRUCTION.
  WHERE REFERENCE IS MADE ON THESE DRAWINGS TO A KERB LINE, IT SHALL BE TAKEN TO MEAN THE KERB INVERT LINE.
  LEVELS FOR KERB AND CHANNEL CONSTRUCTION ARE SHOWN AT LIP OF CHANNEL UNLESS SHOWN

- SHOWN AT LIP OF CHANNEL UNLESS SHOWN OTHERWISE.

  4. LIP LEVELS ARE AT QUARTER POINTS AT TURNOUTS AND AT EQUAL POINTS WHERE INDICATED. (=) KERBS, KERB AND CHANNEL AND SPOON DRAINS SHALL BE CONSTRUCTED IN ACCORDANCE WITH IPSWICH CITY COUNCIL STANDARD DRAWING SR.11.

  5. INVERT DRAINS ACROSS ROAD INTERSECTION SHALL BE IN ACCORDANCE WITH ICC STANDARD DRAWING SR.11. THE CONCRETE SHALL BE CLASS N32 AND THE DEPTH INCREASED BY SOMM TO 175mm AT INVERT. FLUSH KERB TO BE INCREASED IN DEPTH BY SOMM TO 280mm.

  6. GULLY CONNECTIONS AND STORM WATER PIPES SHALL BE 375mm DIAMETER CLASS "2" R.C. PIPES UNLESS SHOWN OTHERWISE.

  7. GULLY PITS ARE TO BE CONSTRUCTED IN ACCORDANCE WITH I.C.C. STANDARD DRAWING SD.04. THE GRATE AND FRAME DETAILS ARE TO BE IN ACCORDANCE WITH I.C.C. STANDARD DRAWING SD.07. ACCESS CHAMBERS ARE TO BE CONSTRUCTED IN ACCORDANCE WITH I.C.C. STANDARD DRAWING SD.07. ACCESS CHAMBERS ARE TO BE CONSTRUCTED IN ACCORDANCE WITH I.C.C. STANDARD DRAWING SD.02. B. GULLY PITS IN EXCESS OF 1.5m DEEP ARE TO BE CONSTRUCTED AS CONSTRUCTED IN ACCORDANCE WITH I.C.C. STANDARD DRAWING SD.02. B. GULLY PITS IN EXCESS OF 1.5m DEEP ARE TO BE CONSTRUCTED AS CONSTRUCTED AS CHAMBERS CHAMBER
- CONSTRUCTED AS A GULLY PIT/ACCESS CHAMBER STRUCTURE. GRATED INLET PITS TO BE CONSTRUCTED IN ACCORDANCE WITH I.C.C. STANDARD DRAWING SD.04.

- 12. THE CONTRACTOR SHALL INITIALLY EXCAVATE THE PAVEMENT BOX TO 250mm BELOW THE FINISHED PAVEMENT LEVEL SHOWN ON THE DRAWINGS. THE CONTRACTOR SHALL THEN NOTIFY THE ENGINEER WHO WILL FIX THE PAVEMENT THICKNESS TO BE CONSTRUCTED FOLLOWING THE RESULTS OF THE SUB-GRADE TESTING.
- FOLLOWING THE RESULTS OF THE SUB-GRADE TESTING.

  13. NOTWITHSTANDING THE LIMITS OF CUTTING AND FILLING SHOWN ON THE DRAWINGS, THE ACTUAL LIMITS SHALL BE DETERMINED ON SITE BY THE ENGINEER AND SIMILARLY THE FINISHED SURFACE CONTOURS MAY BE ADJUSTED BY WRITTEN DIRECTION OF THE ENGINEER DURING CONSTRUCTION.

  14. THE MINIMUM CLEARANCE BETWEEN OUTER WALLS OF PIPES IN MANHOLES SHALL BE
- 150mm.

  15. FLUSHING POINTS SHALL BE INSTALLED IN ACCORDANCE WITH I.C.C. STANDARD DRAWING SR.21. 16. CONSTRUCTION LOAD CONTROL ON THE
- 6. CONSTRUCTION LOAD CONTROL ON THE INSTALLATION OF REINFORCED CONCRETE STORMWATER PIPEWORK SHALL BE UNDERTAKEN IN ACCORDANCE WITH THE RECOMMENDATIONS DEFINED IN THE CONCRETE PIPE ASSOCIATIONS OF AUSTRALASIA'S "INSTALLATIONS OF STEEL REINFORCED CONCRETE PIPES MINIMUM PIPE COVER RECUIRED FOR VARIOUS COMPACTORS". 7. PRIOR TO COMMENCEMENT OF CONSTRUCTION, THE CONTRACTOR SHALL ERECT A STAR PICKET AND 2 STRAND WIRE FENCE TO THE PERIMETER OF VECETATION TO BE RETAINED BE INDUSTRIAL CROSSOVERS ARE TO BE CONSTRUCTED FOR ALL COMBINED DRIVEWAYS.

## DRAWING SCHEDULE

	BASE PLAN, LOCALITY PLAN, DRAWING LIST
9597-33-02	EXISTING SURVEY PLAN (D31-01a ORIGINAL SURVEY
9597-33-03	EARTHWORKS CONTOUR PLAN
9597-33-04	ROAD 1 LONGITUDINAL SECTION
9597-33-05	CROSS SECTION - ROAD 1 SECTION 1
9597-33-06	CROSS SECTION - ROAD 1 SECTION 2
9597-33-07	CROSS SECTION - ROAD 1 SECTION 3
<i>9597–33–08</i>	COMBINED SERVICES PLAN
<i>9597–33–09</i>	STORMWATER PLAN
<i>9597–33–10</i>	STORMWATER LONGITUDINAL SECTIONS
9597-33-11	STORMWATER CATCHMENT PLAN & CALCULATIONS
<i>9597–33–12</i>	STORMWATER MANHOLE & GULLY DETAILS
9597-33-13	SEWERAGE PLAN
<i>9597–33–14</i>	SEWERAGE LONGITUDINAL SECTIONS
<i>9597–33–15</i>	WATER RETICULATION PLAN
<i>9597–33–16</i>	DRIVEWAY PLAN & DETAIL
9597-33-17	SEDIMENT & EROSION CONTROL PLAN

## DASE DIAN LOCALITY DIAN DRAWING LIST

SCALE 1:500 @A1 The areas and distances on this plan are approximate only and are subject to Local

survey.


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Pursuant to Section 336(b) of the Sustainable Planning Act

2009, this plan forms part of

Council's approval for



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REV	DESCRIPTION	DATE	BY
A	PRELIMINARY FOR COMMENT	13-11-12	P.E
В	AMENDMENTS FOR COMMENT	01-03-13	P.E
С	AMENDMENTS FOR APPROVAL	14-03-13	P.E
D	OPERATIONAL WORKS	15-03-13	P.E
Ε	AMENDMENTS FOR APPROVAL	11-06-13	P.E
F	INFORMATION RESPONSE	04-09-13	P.E
l			

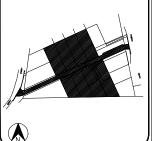**APPROVED** Janul Muchel DANIEL MICHEL RPEQ 3766 DIRECTOR HUNT MICHEL & PARTNERS

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# RANDS DEVELOPMENT NO.2

Ptv Ltd

PROPOSED RECONFIGRATION OF A LOT (LOT 6 INTO 6 LOTS & NEW ROAD)

> Of Lots 38-41 on RP30068 end Lots 9 & 101 on SP127089

# BERRY STREET & PHOENIX COURT, CHURCHILL Packs of PURGA County of CHURCHILL

Level Datum:	A.H.D. vide PSM 30887
Bench Mark	
Location:	Berry Street
Adopted Level:	18.632m AHD
Contour Interval:	0.25m

DRAWING TITLE BASE PLAN, LOCALITY PLAN, DRAWING LIST & NOTES

DESIGNED:	P.E.	JOB No.
DRAWN:	C.R. & B.R.	9597
CHECKED:	D.M.	DWG No.
SCALE:	1:500@A1	9597-33-01

BASE PLAN

NOT TO SCALE



#### <u>LEGEND</u>

WATER MAIN

OVERHEAD POWER

EXISTING SEWER

DRAIN INVERT

CADASTRAL BOUNDARY

EXISTING CONTOURS 1m

EXISTING CONTOURS 0.25m

FENCELINE

I.C.C. STORMWATER PIPE

EX. UNDERGROUND TELSTRA

CROWN OF ROAD


Pursuant to Section 336(b) of the Sustainable Planning Act 2009, this plan forms part of Council's approval for

**Approval No:** 3329/12

**Date:** 24 June 2013

Signed: Colored

Date: 4 February 2014

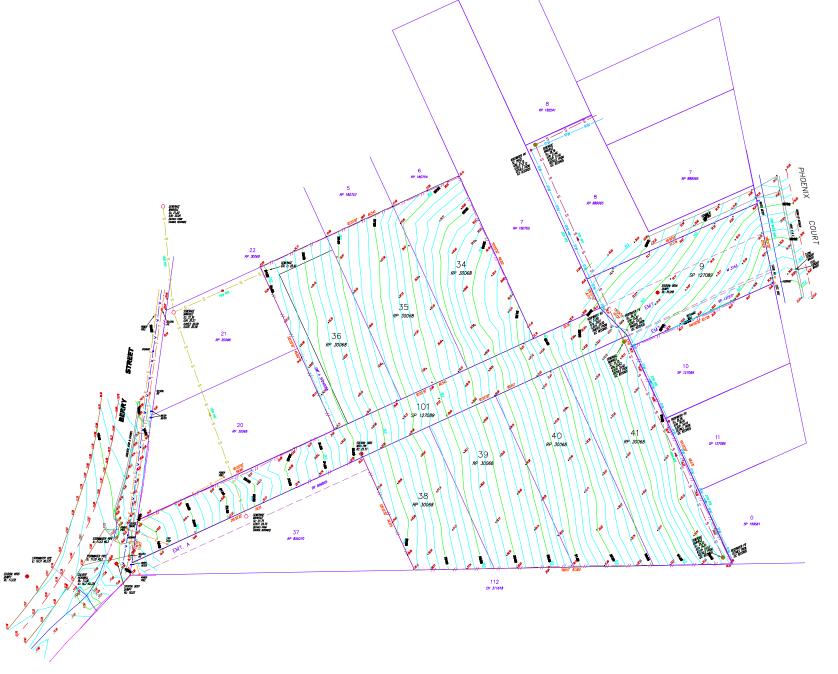

EXISTING SURVEY PLAN
1:500@A1

The areas and distances on this plan are approximate only and are subject to Local Authority approval and final survey.

Authority approval and musiciproval and survey.
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KEY PLAN



			$\Box$
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С	AMENDMENTS FOR APPROVAL	14-03-13	-
D	OPERATIONAL WORKS	15-03-13	-
Ε	AMENDMENTS FOR APPROVAL	11-06-13	7
F	INFORMATION RESPONSE	04-09-13	
l			
l			

APPROVED:

DANIEL MICHEL RPEQ 3766 DIRECTOR HUNT MICHEL & PARTNERS



P.O BOX 867, IPSWICH Q. 4305 77 RODERICK STREET, IPSWICH "BARTLEFRERE" PH 3812 2076 FAX 3812 1614

survey@bairdandhayes.com.au (Survey) planning@bairdandhayes.com.au (Planning)

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> Of Lots 38-41 on RP30068 and Lots 9 & 101 on SP127089

BERRY STREET & PHOENIX COURT, CHURCHILL Paths of FURGA County of CHURCHILL

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Bench Mark	
Location:	Berry Street
Adopted Level:	18.632m AH
Contour Interval:	0.25m

DRAWING TITLE

EXISTING SURVEY PLAN

(formerly D31-01a)

DESIGNED: DRAWN:	C.R. & B.R.	JOB No. 9597
CHECKED:	D.M.	DWG No.
SCALE:	1:500@A1	9597-33-02





<u>LEGEND</u>

EXTENT OF FILL

EXTENT OF CUT

PROPOSED CONTOURS 1m

PROPOSED CONTOURS 0.25m

EXISTING CONTOUR 0.5m

- EARTHWORKS & ALLOTMENT NOTES:

  1. REMOVE ALL TOPSOIL, VEGETATION AND DELETERIOUS MATERIAL FROM EARTHWORKS ZONES.

  2. PROOF ROLL SUBGRADE TO DETECT ANY SOFT SPOTS. SOFT SPOTS SHALL BE REMOVED AND BACKFILLED WITH APPROVED SUB-BASE MATERIAL.

  3. MAXIMUM BATTER SLOPE TO BE 1:4 (V:H) UNLESS NOTED OTHERWISE. (MAX 1:6 WITHIN ROAD SURFACE)
- ROAD SURFACE)

  4. IPSWICH CITY COUNCIL REQUIRES ALL COMPACTION OF FILL TO HAVE LEVEL 1 SUPERVISION.

- COMPACTION OF FILL TO HAVE LEVEL 1
  SUPERVISION.

  5. ALLOTMENT FILLING AND TESTING OF
  ALLOTMENT FILLING SHALL BE CARRIED OUT
  IN ACCORDANCE WITH AS.3798 AND IPSWICH
  CITY COUNCIL REQUIREMENTS.

  6. TEST RESULTS ARE TO BE MADE AVAILABLE
  TO THE SUPERINTENDENT UPON REQUEST.

  7. IMPORTED FILL TO BE MINIMUM CBRIS
  MATERIAL, PLACED IN MAXIMUM 150mm
  LAYERS AND PLACED AT OPTIMUM MOISTURE
  CONTENT AND COMPACTED TO 98%
  STANDARD MAXIMUM DRY DENSITY AS
  DEFINED BY AS.1289.5.1.1

  8. A TOPSOIL DEPTH OF 150mm HAS BEEN
  USED TO DETERMINE THE EARTHWORKS
  QUANTITIES. THE CONTRACTOR IS TO SATISFY
  THEMSELVES OF THE ACCURACY OF THESE
  QUANTITIES AND MAKE ANY NECESSARY
  ALLOWANCES IF THEY DISAGREE WITH THEM.

  9. ALL TOPSOIL IS TO BE STRIPPED AND
  STOCKPILED PRIOR TO THE COMMENCEMENT
  OF ANY EARTHWORKS.

ALL FINISHED LEVELS SHOWN ARE FINISHED TOP OF TOPSOIL OR TOP OF CONCRETE LEVELS.

REFER TO DRAWINGS 9597-33-17 FOR EROSION AND SEDIMENT CONTROL MEASURES.

FOR DRIVEWAY DETAILS REFER TO DRAWING 9597-33-16


FOR EXISTING SERVICES REFER TO ORIGINAL SURVEY DRAWING *9597–33–02*. (formerly D31-01a)

Pursuant to Section 336(b) of the Sustainable Planning Act 2009, this plan forms part of Council's approval for

**Approval No:** 3329/12

**Date:** 24 June 2013

Date: 4 February 2014

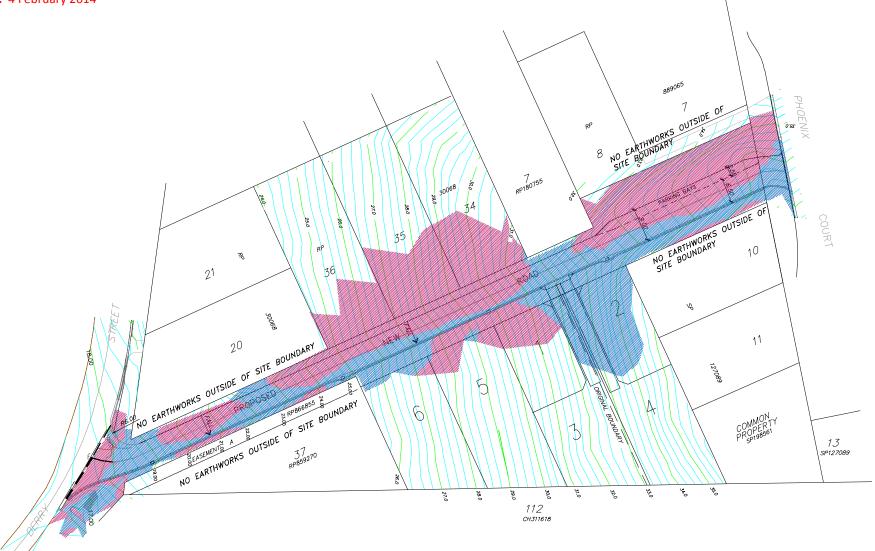


EARTHWORKS CONTOUR PLAN

1:500@A1

SCALE 1:500 @A1 The areas and distances on this plan are approximate only and are subject to Local Authority approval and final

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KEY PLAN



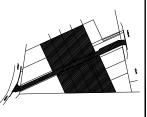

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F	INFORMATION RESPONSE	04-09-13	P.E
П			
11		1	

APPROVED: Janul Muchel DANIEL MICHEL RPEQ 3766 DIRECTOR HUNT MICHEL & PARTNERS

### BAIRD 🔾 HAYES SURVEYORS - TOWN PLANNERS

P.O BOX 867, IPSWICH Q. 4305 77 RODERICK STREET, IPSWICH "BARTLEFRERE" PH 3812 2076 FAX 3812 1614

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#### RANDS DEVELOPMENT NO.2 Pty Ltd

PROJECT

PROPOSED RECONFIGRATION
OF A LOT (LOT 6 INTO 6 LOTS
& NEW ROAD)

Of Lots 38-41 on RP30068 and Lots 9 & 101 on SP127089

BERRY STREET & PHOENIX COURT. CHURCHILL
Paciety of PURGA County of CHURCHILL


(, , , , ,	A.H.D. vide PSM 30887
Level Datum:	PSM 30887
Bench Mark	
Location:	Berry Street
Adopted Level:	18.632m AHD
Contour Interval:	0.25m

DRAWING TITLE

EARTHWORKS CONTOUR


PLAN


DESIGNED: DRAWN:	C.R. & B.R.	JOB No. 9597
CHECKED:	D.M.	DWG No.
SCALE:	1:500@A1	9597-33-03

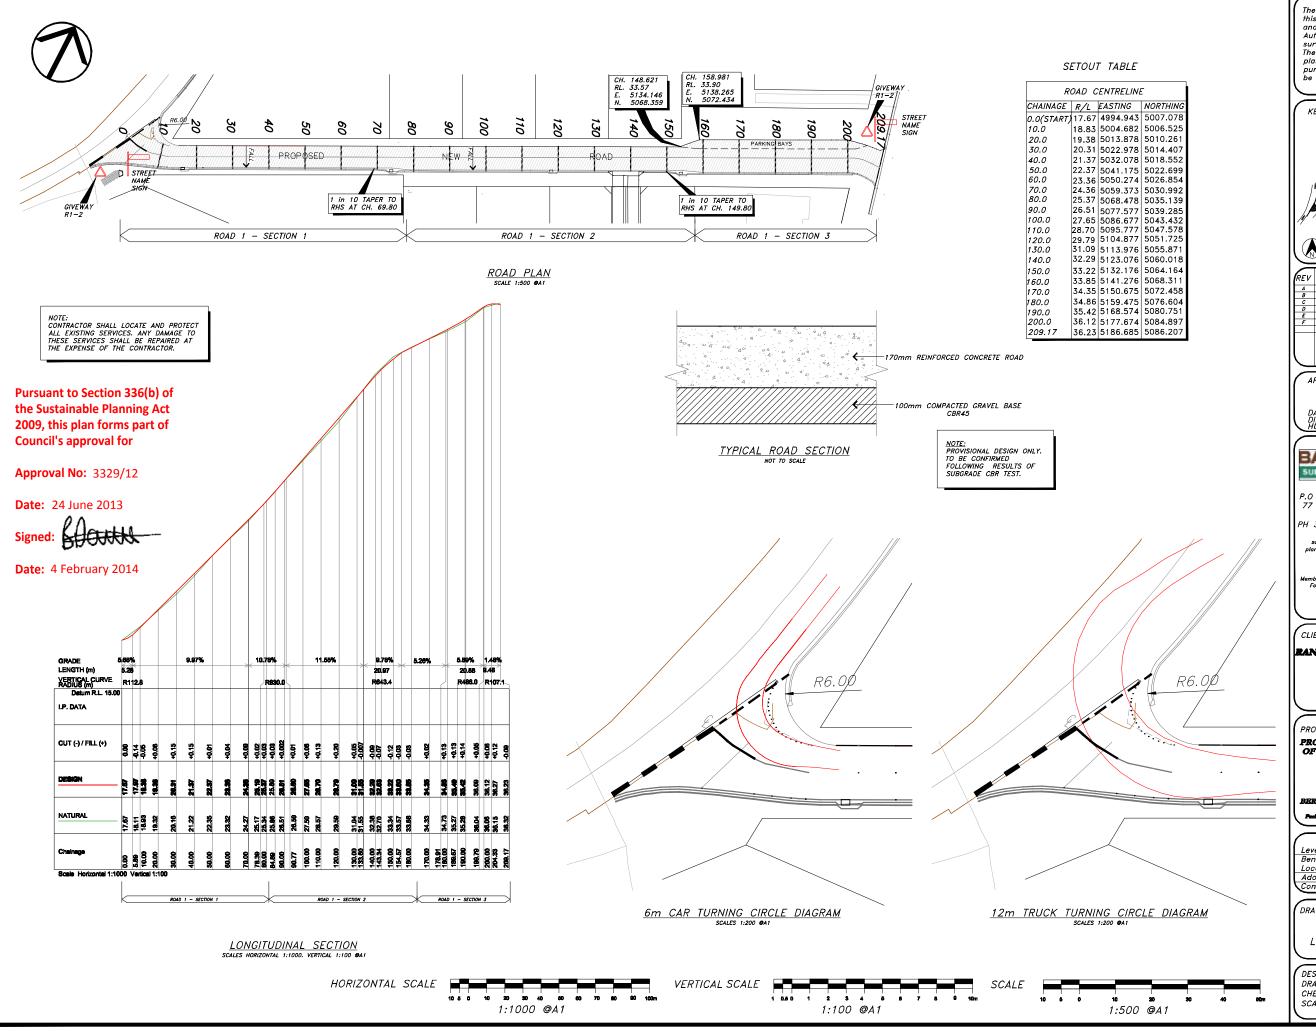

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KEY PLAN



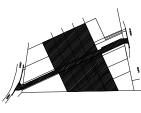

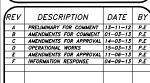APPROVED:

Daniel Michel DANIEL MICHEL RPEQ 3766 DIRECTOR HUNT MICHEL & PARTNERS

#### BAIRD 🤤 HAYES SURVEYORS - TOWN PLANNER

P.O BOX 867, IPSWICH Q. 4305 77 RODERICK STREET, IPSWICH
"BARTLEFRERE" PH 3812 2076 FAX 3812 1614

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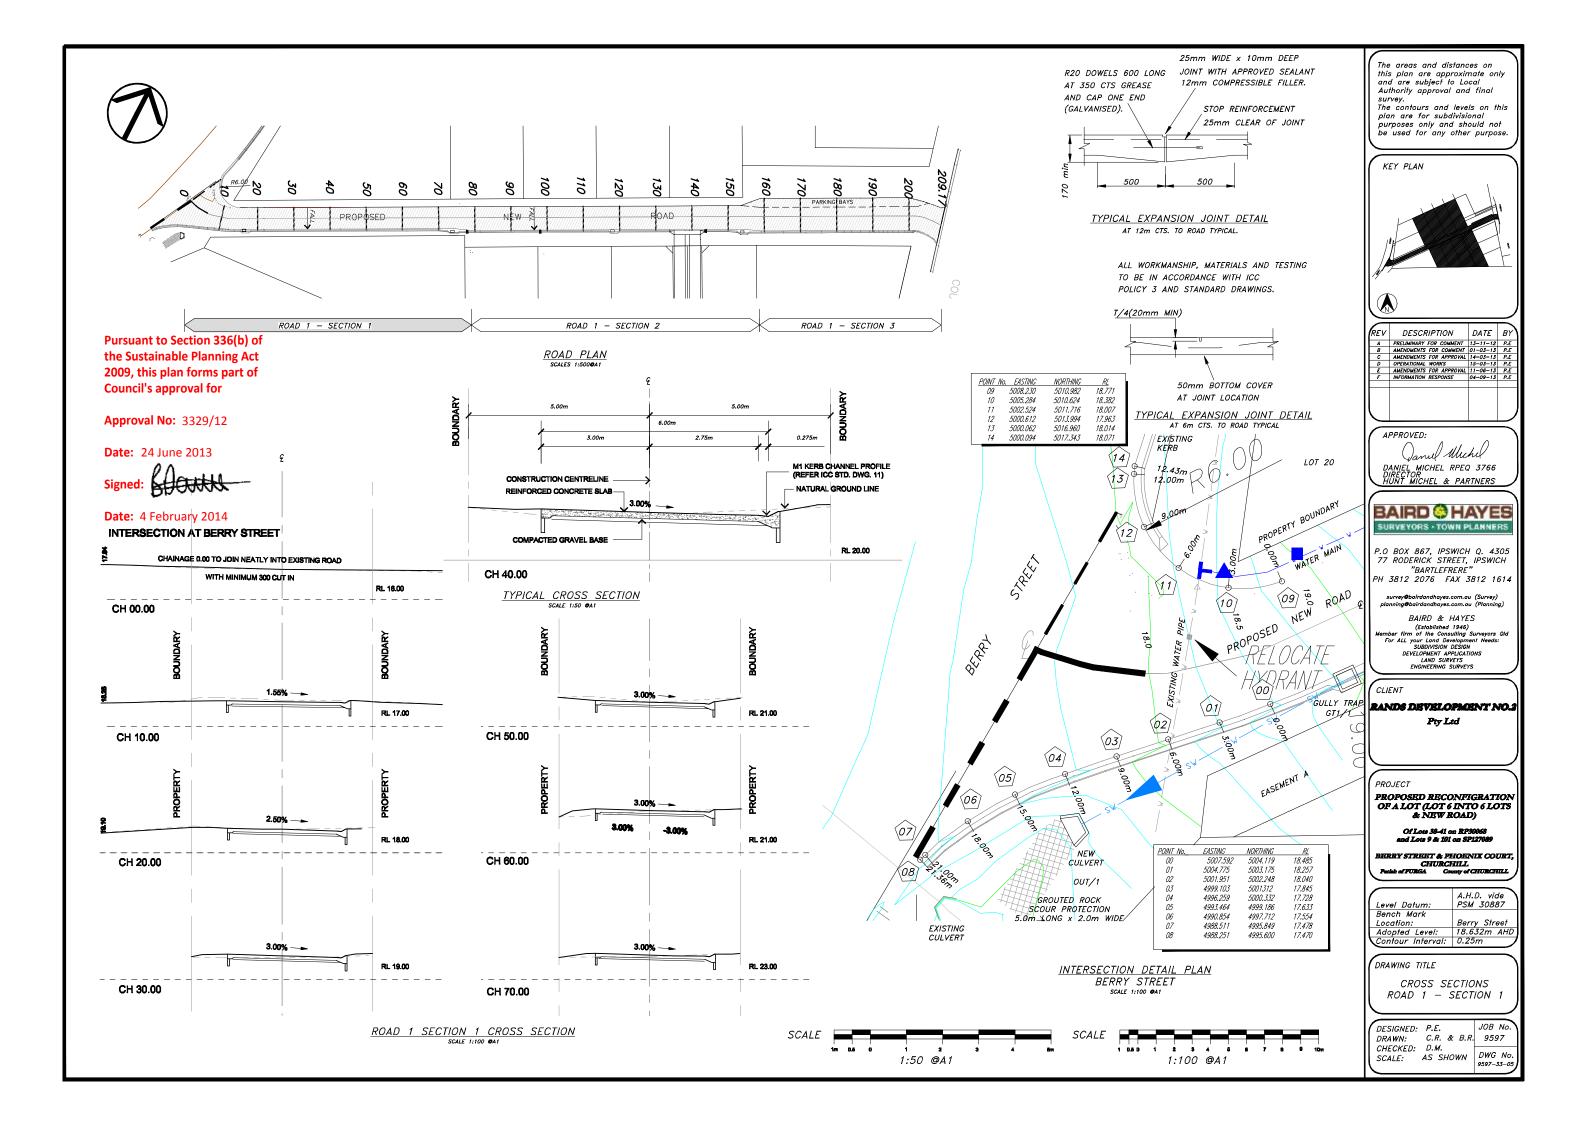
BERRY STREET & PHOENIX COURT CHURCHILL
Penish of PURGA County of CHURCI


Level Datum:	A.H.D. vide PSM 30887
Bench Mark	7 3W 30007
Location:	Berry Street
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DRAWING TITLE

ROAD 1 LONGITUDINAL SECTION


DESIGNED:	P.E.	JOB No.
DRAWN:	C.R. & B.R.	9597
CHECKED:	D.M.	
SCALE:	AS NOTED	DWG No. 9597-33-04
•		



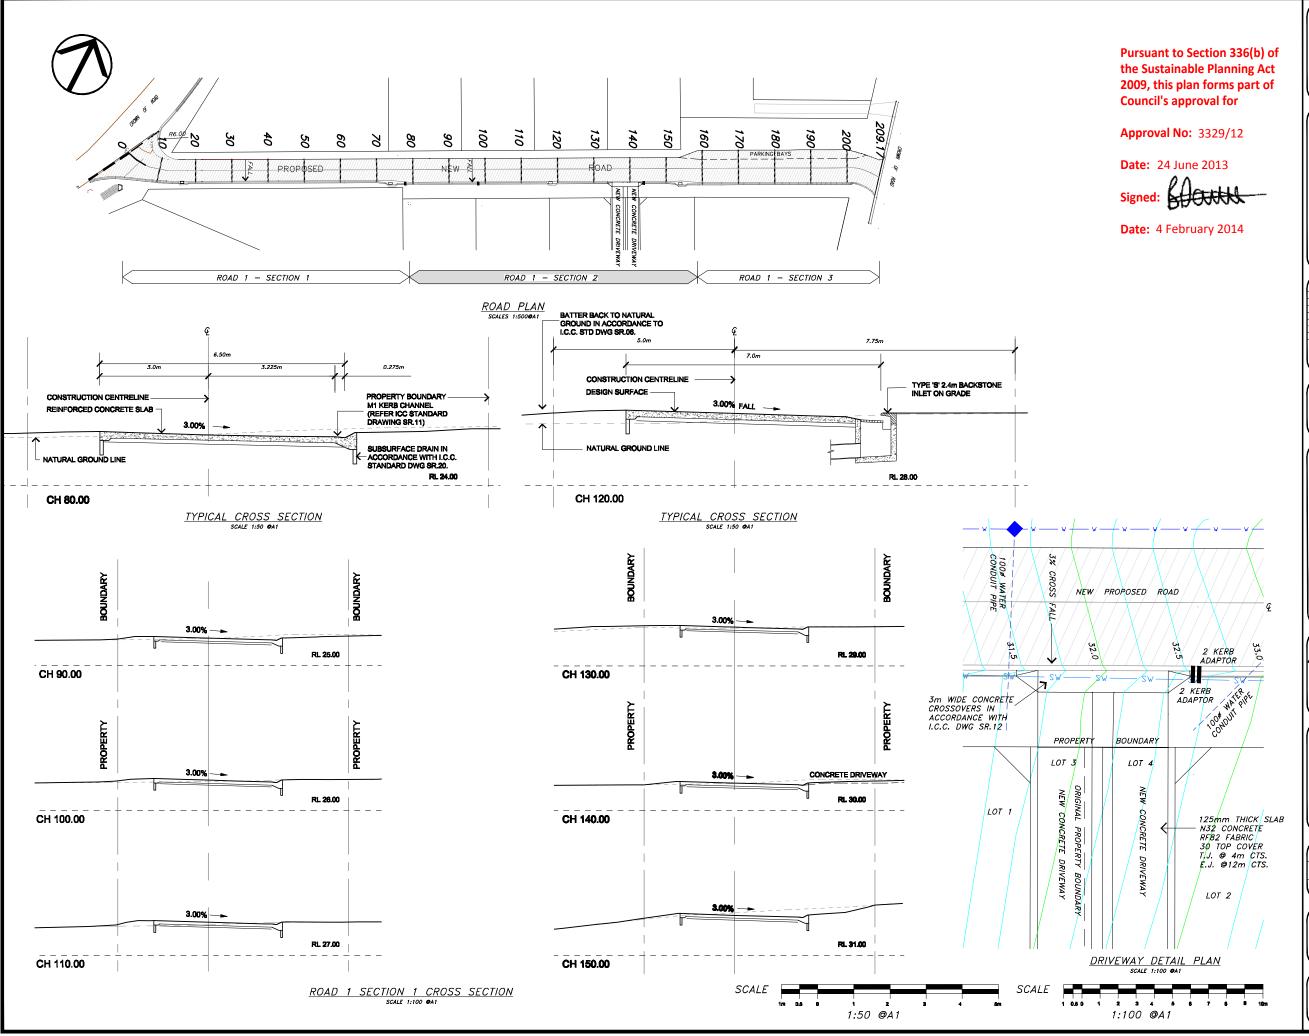

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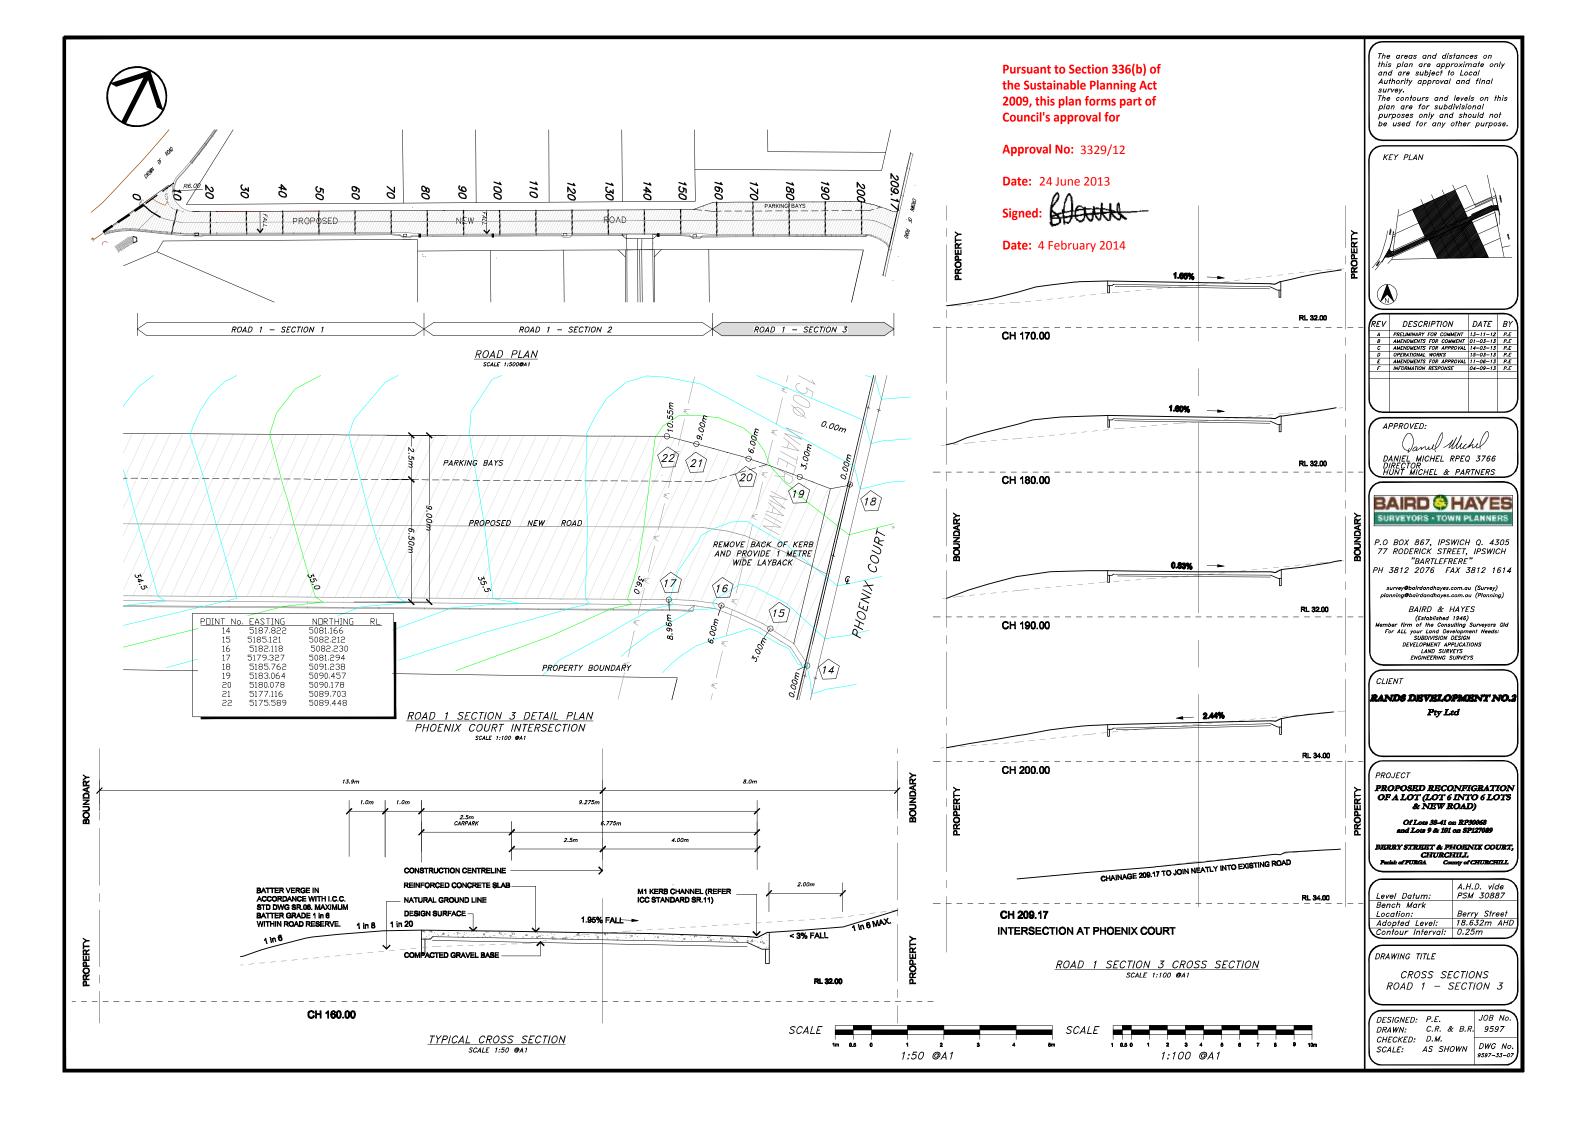
BERRY STREET & PHOENIX COURT, CHURCHILL, Packet of FURGA County of CHURCHILL

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DRAWING TITLE

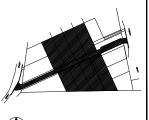CROSS SECTIONS ROAD 1 - SECTION 2


DRAWN:	P.E. C.R. & B.R.	JOB No. 9597
CHECKED: SCALE:	D.M. AS SHOWN	DWG No. 9597-33-06





CADASTRAL BOUNDARY	
WATER MAIN	— v — v —
PROPOSED SEWER	— s —— s —
DRAIN INVERT	
STORMWATER PIPE	— sw — sw —
ROOFWATER PIPE	
ALT. ROOFWATER PIPE	
CROWN OF ROAD	-
EX. ROOFWATER PIPE	
EX. UNDERGROUND TELSTRA	ттт
EX. OVERHEAD POWER	— Е — Е —
EX. SEWER PIPE	— s —— s —

Pursuant to Section 336(b) of 2009, this plan forms part of Council's approval for

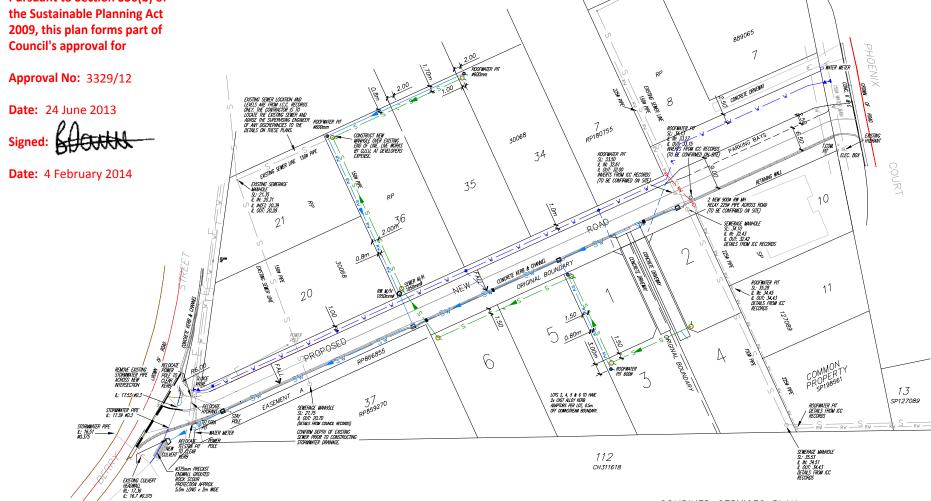

COMBINED SERVICES PLAN



#### STORMWATER DRAINAGE NOTES:

- ALL CONSTRUCTION TO BE IN ACCORDANCE WITH I.C.C.
  PLANNING SCHEME "POLICY 3 GENERAL WORKS" AND
  STANDARD DRAWINGS.
- ALL STORMWATER PIPES ARE TO BE RCP CLASS 2 OR FRC
- PIPES 600 DIA OR LESS TO BE SPIGOT AND SOCKET WITH RUBBER RING JOINTS. PIPES GREATER THAN 600 DIA TO BE INTERNAL FLUSH JOINTED WITH PIPE MANUFACTURER'S PROPRIETARY EXTERNAL BANDS.
- PIPES SHALL BE BEDDED IN ACCORDANCE WITH ICC DRAWING
- BACK FILLING OF TRENCHES UNDER ROADS SHALL BE IN ACCORDANCE WITH ICC DRAWING SD.11A.
- ALL GULLY PITS ARE TO BE CONCRETE WITH GALVANISED STEEL GRATES IN ACCORDANCE WITH ICC SD.04A AND SD.07A STANDARD DRAWINGS RESPECTIVELY.
- ALL GULLY PITS ARE TO HAVE LINTELS IN ACCORDANCE WITH ICC SD.06A. REFER TO STORMWATER LONG SECTION FOR SIZES.
- GULLY PITS AND MANHOLES ARE TO HAVE STEP RUNGS IN ACCORDANCE WITH ICC SD. 10A.
- ALL END WALL OUTLETS ARE TO BE IN ACCORDANCE WITH QLD
- ALL MANHOLES ARE TO BE IN ACCORDANCE WITH ICC SD.02A.
  REFER TO LONG SECTIONS FOR SIZES. ALL MANHOLES ARE TO
  HAVE BOLT DOWN CAST IRON COVER AND FRAME.
- FINAL FORM OF ALL STORMWATER DRAINAGE OUTLETS ARE SUBJECT TO COUNCIL APPROVAL.

ROOFWATER DRAINAGE NOTES:
1. ALL CONSTRUCTION TO BE IN ACCORDANCE WITH I.C.C. PLANNING SCHEME "POLICY 3 - GENERAL WORKS" AND STANDARD DRAWINGS

- ROOFWATER ALIGNMENT TO BE 0.6m FROM REAR PROPERTY BOUNDARIES AND 1.2m FROM SIDE BOUNDARIES UNO.
- SEWERS PARALLEL TO ROOFWATER LINES TO BE LOCATED ON A 2.0m ALIGNMENT. ROOFWATER HOUSE CONNECTION BRANCHES TO EXTEND 0.5m PAST THE CENTRE OF THE SEWER MAIN. A 1.0m SEPARATION TO BE PROVIDED BETWEEN SEWER AND
- ALL PIPES ARE TO BE UPVC SEWER CLASS SH SOLVENT WELDED TO AS1260 OR FRC CLASS 2 R.R.J TO AS4139 OR RC CLASS 2 R.R.J TO AS1342.
- ACCESS CHAMBERS ARE TO BE CONSTRUCTED IN ACCORDANCE WITH ICC DWG SD.12 AND SHALL BE: 600mm# FOR DEPTHS UP TO 750mm 900mm# FOR DEPTHS 750mm TO 1500mm 1050mm# FOR DEPTHS >1500mm

- ROOFWATER HOUSE CONNECTIONS ARE TO BE 100mm TYPE A UNO IN ACCORDANCE WITH SEWER STANDARDS ICC SS.10D.
- ALL PIPES ARE TO HAVE 450mm MINIMUM COVER.

#### SEWERAGE RETICULATION NOTES


- ALL CONSTRUCTION IS TO BE IN ACCORDANCE WITH I.C.C. PLANNING SCHEME "POLICY 3 GENERAL WORKS" AND STANDARD DRAWINGS.
- IT IS THE CONTRACTOR'S RESPONSIBILITY TO ASCERTAIN THE LOCATION AND DEPTH OF ALL PUBLIC UTILITIES WHICH MAY BE AFFECTED BY THIS PLAN PRIOR TO COMMENCING WORK.
- ALL SEWERAGE CONSTRUCTION WORK UNDERTAKEN BY THE CONTRACTOR IS TO COMPLY WITH THE REQUIREMENTS OF THE QUEENSLAND WORKPLACE HEALTH AND SAFETY ACT.
- THE CONTRACTOR TO VERIFY FINISHED SURFACE LEVELS ON SITE BEFORE CONSTRUCTION OF SEWERS AND HOUSE CONNECTION BRANCHES.
- ALL WORK ASSOCIATED WITH LIVE SEWERS OR MANHOLES TO BE CARRIED OUT BY Q.U.U. AT DEVELOPER'S EXPENSE.
- ALL ACCESS CHAMBERS ARE TO BE 1050# PRECAST OR CAST-INSITU IN ACCORDANCE WITH ICC SS.03A AND SS.02A STANDARD DRAWINGS RESPECTIVELY. THE SURFACE LEVEL OF CHAMBERS ARE TO BE 50 TO 75mm HIGHER THAN SURROUNDING FINISHED SURFACE LEVELS. THE DESIGN FINISHED SURFACE LEVELS. THE DESIGN FINISHED SURFACE LEVELS ARE A GUIDE ONLY.
- ALL HOUSE CONNECTION BRANCHES ARE TO EXTEND 600mm MIN INTO PROPERTY AND ARE TO BE CONSTRUCTED IN ACCORDANCE WITH ICC SS.10D STANDARD DRAWING.
- END OF LINE MANHOLES ARE TO BE CONSTRUCTED IN ACCORDANCE WITH ICC STD DWG SS.24.
- ALL HOUSE CONNECTION INVERT LEVELS AS SHOWN ON THESE DRAWINGS ARE THE HIGHEST POSSIBLE LEVEL TO CONTROL THE ALLOTMENT. ANY HOUSE CONNECTION LAID TO A HIGHER LEVEL SHALL BE RECTIFIED AT THE CONTRACTORS COST.
- CONNECTION TO EXISTING MANHOLES ARE TO BE MADE BY Q.U.U UNLESS DIRECTED IN WRITING OTHERWISE BY Q.U.U.
- ALL SEWER PIPES ARE TO BE U.P.V.C. CLASS SN8. 100mm HOUSE CONNECTION BRANCHES TO BE U.P.V.C. CLASS SN4.
- ALL PIPE WORK IS TO BE TESTED TO THE SATISFACTION OF THE ENGINEER AND COUNCIL PRIOR TO CONNECTION TO THE COUNCIL MAINS.
- ALL SEWER LINES TO BE PRESSURE TESTED WITH AIR. PRESSURE TEST TO 30kPa MIN AND HOLD FOR 3 MINUTES. PRESSURE MUST NOT FALL BELOW 25kPa IN 3 MINUTES.
- COMPLY WITH ALL REQUIREMENTS OF THE SEWERAGE AND WATER SUPPLY ACT.

The areas and distances on this plan are approximate only and are subject to Local Authority approval and final

survey.

The contours and levels on this plan are for subdivisional purposes only and should not be used for any other purpose.

KEY PLAN

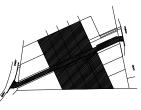



REV	DESCRIPTION	DATE	BY
I A	PRELIMINARY FOR COMMENT	13-11-12	P.E
В	AMENDMENTS FOR COMMENT	01-03-13	P.E
С	AMENDMENTS FOR APPROVAL	14-03-13	P.E
D	OPERATIONAL WORKS	15-03-13	P.E
Ε	AMENDMENTS FOR APPROVAL	11-06-13	P.E
F	INFORMATION RESPONSE	04-09-13	P.E

APPROVED:

Janul Muchel DANIEL MICHEL RPEQ 3766 DIRECTOR HUNT MICHEL & PARTNERS

### BAIRD @ HAYES SURVEYORS - TOWN PLANNERS

P.O BOX 867, IPSWICH Q. 4305 77 RODERICK STREET, IPSWICH "BARTLEFRERE" PH 3812 2076 FAX 3812 1614

BAIRD & HAYES

BAIRU & THATES (Established 1946) firm of the Consulting Survey ALL your Land Development No SUBDIVISION DESIGN DEVELOPMENT APPLICATIONS LAND SURVEYS ENGINEERING SURVEYS

CLIENT

#### RANDS DEVELOPMENT NO.2 Ptv Ltd

PROPOSED RECONFIGRATION OF A LOT (LOT 6 INTO 6 LOTS & NEW ROAD)

> Of Lots 38-41 on RP30068 end Lots 9 & 101 on SP127089


BERRY STREET & PHOENIX COURT, CHURCHILL Paids of PURGA County of CHURCHILL


Level Datum:	A.H.D. vide PSM 30887
Bench Mark	
Location:	Berry Street
Adopted Level:	18.632m AHD
Contour Interval:	0.25m

DRAWING TITLE

COMBINED SERVICES PLAN


DESIGNED: DRAWN:	C.R. & B.R.	JOB No 9597
CHECKED:	D.M.	DWG No
SCALE:	1:500@A1	9597-33-0

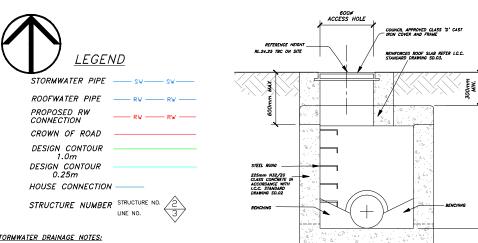

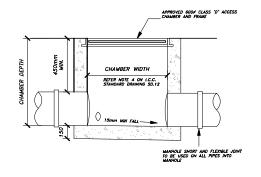


TYPICAL ROOFWATER INSPECTION CHAMBER SECTION

SCALE 1:20@A1

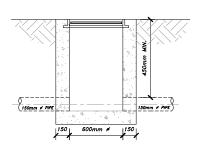

TYPICAL FIELD INLET SECTION

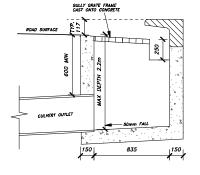

TYPICAL GRATED INLET SECTION
REFER I.C.C. STANDARD DRAWING SD.04
SCALE 1:20@A1

#### STORMWATER DRAINAGE NOTES:

- ALL CONSTRUCTION TO BE IN ACCORDANCE WITH I.C.C.
  PLANNING SCHEME "POLICY 3 GENERAL WORKS" AND STANDARD DRAWINGS.
- ALL STORMWATER PIPES ARE TO BE RCP CLASS 2 OR FRC
- PIPES 600 DIA OR LESS TO BE SPIGOT AND SOCKET WITH RUBBER RING JOINTS. PIPES GREATER THAN 600 DIA TO BE INTERNAL FLUSH JOINTED WITH PIPE MANUFACTURER'S PROPRIETARY EXTERNAL BANDS.
- PIPES SHALL BE BEDDED IN ACCORDANCE WITH ICC DRAWING SD.11A.
- BACKFILLING OF TRENCHES UNDER ROADS SHALL BE IN ACCORDANCE WITH ICC DRAWING SD.11A.
- ALL GULLY PITS ARE TO BE CONCRETE WITH GALYANISED STEEL GRATES IN ACCORDANCE WITH ICC SD.04A AND SD.07A STANDARD DRAWINGS RESPECTIVELY.
- ALL GULLY PITS ARE TO HAVE LINTELS IN ACCORDANCE WITH
- GULLY PITS AND MANHOLES ARE TO HAVE STEP RUNGS IN ACCORDANCE WITH ICC SD.10A.
- ALL END WALL OUTLETS ARE TO BE IN ACCORDANCE WITH QLD TRANSPORT STANDARD DRAWING NO. 1305. ALL MANHOLES ARE TO BE IN ACCORDANCE WITH ICC SD.02A.
  REFER TO LONGSECTIONS FOR SIZES. ALL MANHOLES ARE TO
- HAVE BOLT DOWN CAST IRON COVER AND FRAME. FINAL FORM OF ALL STORMWATER DRAINAGE OUTLETS ARE SUBJECT TO COUNCIL APPROVAL.

- ROOFWATER DRAINAGE NOTES:
  1. ALL CONSTRUCTION TO BE IN ACCORDANCE WITH I.C.C. PLANNING SCHEME "POLICY 3 - GENERAL WORKS" AND STANDARD DRAWINGS.
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- ALL PIPES ARE TO BE UPVC SEWER CLASS SH SOLVENT WELDED TO AS1260 OR FRC CLASS 2 R.R.J TO AS4139 OR RC CLASS 2 R.R.J TO AS1342.
- ACCESS CHAMBERS ARE TO BE CONSTRUCTED IN ACCORDANCE WITH ICC DWG SD.12 AND SHALL BE:
  600mmø – FOR DEPTHS UP TO 750mm
  900mmø – FOR DEPTHS >550mm TO 1500mm
  1050mmø – FOR DEPTHS >1500mm
- ROOFWATER HOUSE CONNECTIONS ARE TO BE 100mm TYPE A UNO IN ACCORDANCE WITH SEWER STANDARDS ICC SS.10D.
- ALL PIPES ARE TO HAVE 450mm MINIMUM COVER.


ST	STORMWATER SETOUT		
M/H	S/L	EASTING	NORTHING
OUT/1	17.45	4997.167	4997.552
GT1/1	18.85	5012.429	5005.403
GT2/1	24.65	5065.070	5028.837
GT3/1	29.65	5105.311	5047.164
GT4/1	33.50	5137.542	5061.796
1/2	24.70	5060.632	5038.105
2/2	23.97	5040.726	5081.545
3/2	27.60	5078.514	5098.865
1/3	29.83	5107.175	5043.274
2/3	30.44	5119.115	5017.217

# TYPICAL STORMWATER ACCESS CHAMBER SECTION WHERE DEPTH < 3000mm REFER I.C.C. STANDARD DRAWING SD.02 SCALE 1:20@A1

225

1050

Pursuant to Section 336(b) of the Sustainable Planning Act 2009, this plan forms part of Council's approval for

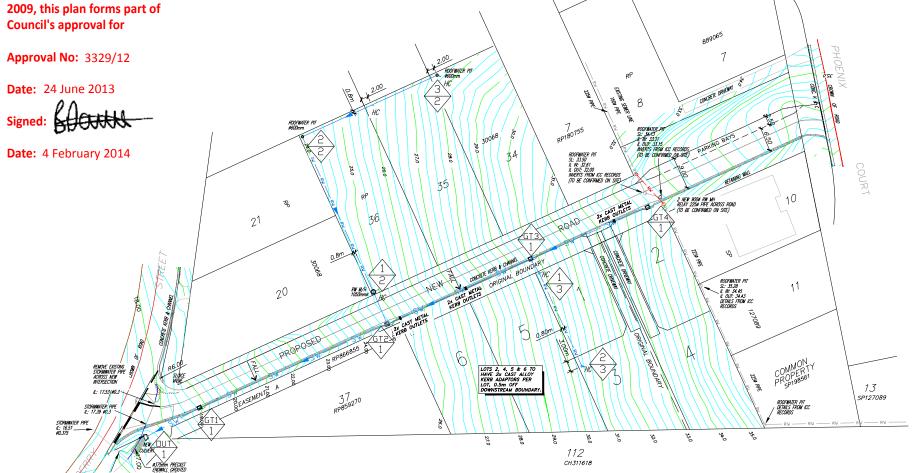


STORMWATER PLAN

0.1 0 0.2 0.4 0.8 0.8 1.0m 1.2 1.4 1.8 1.8 2.0m 1:500 @A1 1:20 @A1

The areas and distances on this plan are approximate only and are subject to Local Authority approval and final survev.

survey.

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В	AMENDMENTS FOR COMMENT	01-03-13	P.E
С	AMENDMENTS FOR APPROVAL	14-03-13	P.E
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F	INFORMATION RESPONSE	04-09-13	P.E
	-		

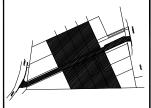APPROVED:

Janul Michel DANIEL MICHEL RPEQ 3766 DIRECTOR HUNT MICHEL & PARTNERS



P.O BOX 867, IPSWICH O. 4305 "BARTI FERERE" PH 3812 2076 FAX 3812 1614

BAIRD & HAYES DAINU & THAILS

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For ALL you Land Development Needs:
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DEVELOPMENT APPLICATIONS
LAND SURVEYS
ENGINEERING SURVEYS

CLIENT

RANDS DEVELOPMENT NO.2 Ptv Ltd

PROPOSED RECONFIGRATION OF A LOT (LOT 6 INTO 6 LOTS & NEW ROAD)

Of Lots 38-41 on RP30068 and Lots 9 & 101 on SP127089 BERRY STREET & PHOENIX COURT, CHURCHILL Packs of PURGA County of CHURCHILL

A.H.D. vide PSM 30887 Location: Berry Street
Adopted Level: 18.632m AHD
Contour Interval: 0.25m

DRAWING TITLE

STORMWATER PLAN

DESIGNED:	P.E.	JOB No.
DRAWN:	C.R. & B.R.	9597
CHECKED:	D.M.	DWG No.
SCALE:	AS SHOWN	9597-33-09

- NOTES:

  1. THE CONTRACTOR IS TO VERIFY
  EXISTING SEWER LEVELS PRIOR TO
  COMMENCEMENT OF CONSTRUCTION.

  2. THE CONTRACTOR IS TO VERIFY ALL
  FINISHED SURFACE LEVELS OF THE
  PROPOSED MAINTENANCE HOLES
  BEFORE CONSTRUCTION TO FINISHED
  LEVELS.


  3. THE CONTRACTOR IS TO NOTIFY THE
  SUPERVISING ENGINEER OF ANY
  DISCREPANCIES BETWEEN THE DESIGN
  PLANS AND THE CONDITIONS ON SITE
  PRIOR TO COMMENCEMENT OF ANY
  PIPE LAYING
  4. HOUSE CONNECTIONS HAVE BEEN
  DESIGNED TO CONTROL ALL OF THE
  BLOCK AT A GRADE OF 1:60 AT A
  MAXIMUM DEPTH OF PROPERTY
  CONNECTION OF 1.80m UNLESS
  OTHERWISE STATED.

Pursuant to Section 336(b) of the Sustainable Planning Act 2009, this plan forms part of Council's approval for

**Approval No:** 3329/12

**Date:** 24 June 2013

Date: 4 February 2014

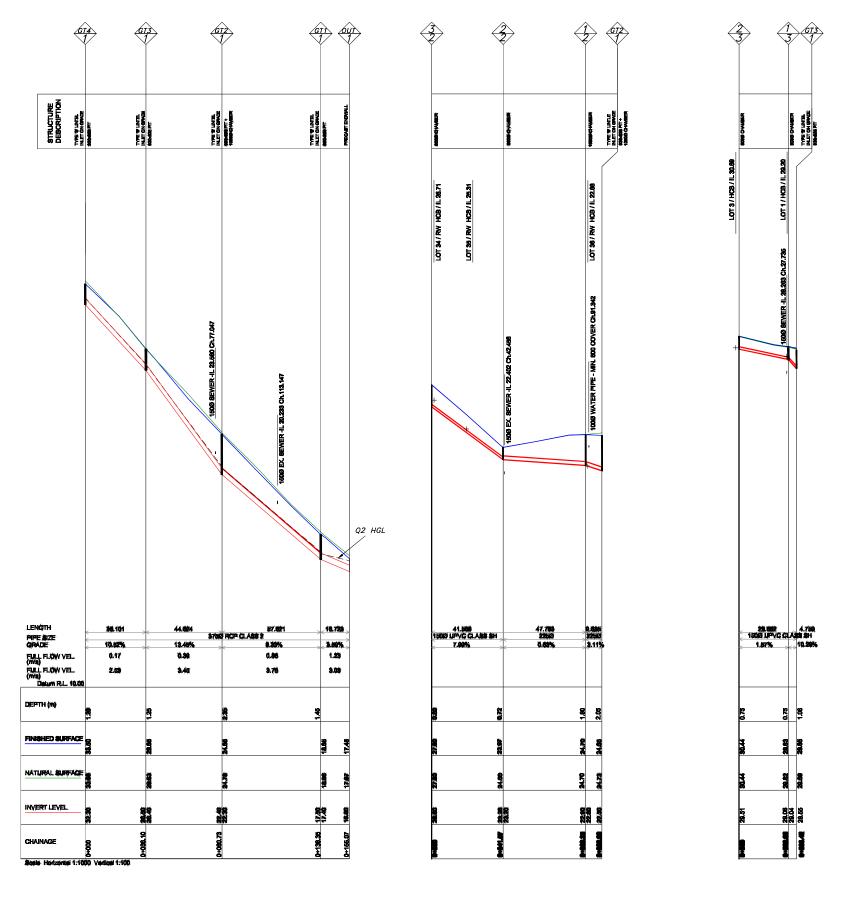

STORMWATER LINE 1 ROOFWATER LINE 2 ROOFWATER LINE 3




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Authority approved. 2...

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KEY PLAN



APPROVED: Daniel Muchel

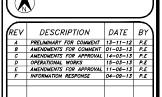DANIEL MICHEL RPEQ 3766 DIRECTOR HUNT MICHEL & PARTNERS

## BAIRD 🤤 HAYES SURVEYORS - TOWN PLANNERS

P.O BOX 867, IPSWICH Q. 4305 77 RODERICK STREET, IPSWICH "BARTLEFRERE" PH 3812 2076 FAX 3812 1614

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BERRY STREET & PHOENIX COURT, CHURCHILL Packet of PURGA County of CHURCHILL

Level Datum:	A.H.D. vide \\\\\\\\\\\\\\\\\\\\\\\\\\\\\\\\\\\\
Bench Mark	F3M 30007
Location:	Berry Street
Adopted Level:	18.632m AHD
Contour Interva	I: 0.25m

DRAWING TITLE

STORMWATER LONGITUDINAL SECTIONS

DESIGNED: DRAWN:	C.R. & B.R.	JOB No. 9597
CHECKED: SCALE:	D.M. AS SHOWN	DWG No.



CATCHMENT BOUNDARY -----DESIGN CONTOUR 1.0m DESIGN CONTOUR 0.25m EXISTING CONTOUR 0.50m

# CATCHMENT AREAS MARK AREA (m2) 964m² 630m² 1373m²


2014m²

Pursuant to Section 336(b) of the Sustainable Planning Act 2009, this plan forms part of **Council's approval for** 

**Approval No:** 3329/12

**Date:** 24 June 2013


Date: 4 February 2014

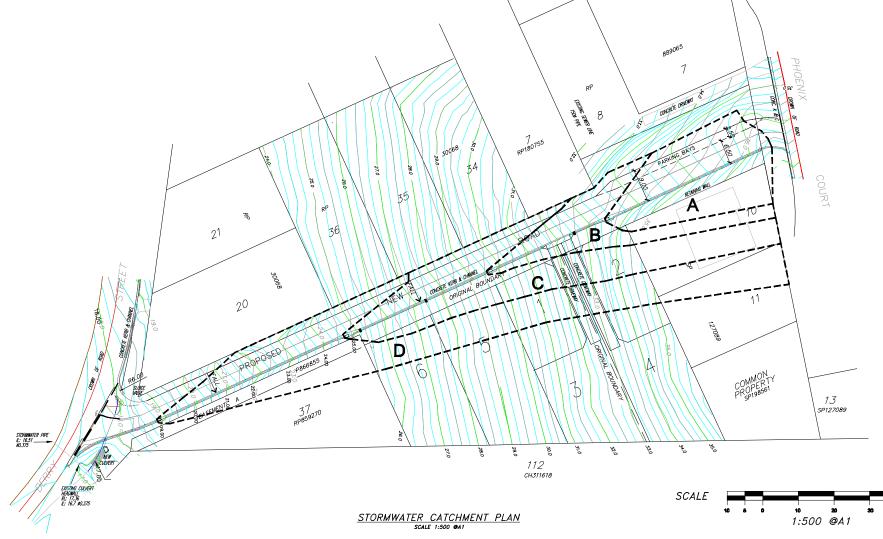

STORMWATER LINE: 1  EVENT: Q2  GT 4 GT 3 A 13 23 00 2850 8.886 0.084 0.985 0.987 8.000 123 0.000 0.000 0.98 0 0.057 8.000 123 0.000 0.000 0.98 0 0.057 1.000 0.000	LATERAL NELOW	US STRUCTURE No	DISSTRUCTURENO SUB CATCHMENT LABEL	TIME OF CONC	SUBCATCHMENT	DIS IT	LENGTHOFPIPE	AREA OF SUBCATCHMENT	COEFF OF RUNOFF OF SUB-CATCHMENT	FOUNALENT IMPERATIOUS AREA	TIME OF CONC CRITCIAL	RANFALL INTENSITY	SUB-CATCHMENT	BYPASS	INLET TYPE	SSTANI	TOTAL IMPERVIOUS AREA	BYPASS +LATERAL	SLOPE OF PIPE SECTION	PIPE DIANETER REQUIRED	PIPE DIAMETER ADOPTED	PPEFLOWVELOCITY	TIME THROUGH PIPE	OgiOo	ongo	Duño	QUDMICHARTNO	HEAD LOSS COEFF (Ku)	(Kw)	VELOGITYHEAD	STRUCTURE HEAD LOSS PIPE HYDRAULIC		STRUCTURE D/S HGL	STRUCTURE UISHGL	STRUCTURE W.S.E.		KERB LIP TYPICAL)	SDo	COVER UPSTREAM	COVER DOVANSTREAM	FREEBOARD	SLOPE OF HGL
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0.016 GT2 GT1 C/RW 13 22.40 17500 57.62 0.1773 0.595 0.105 13.22 172 0.095 0.096 0.096 0.096 0.095 0.194 0.375 0.455 1.000 48 1.70 170 0.098 0.095 0.000 0.44 22.775 22.840 22.840 GT2 24.650 1.2 1.875 0.075 0.275 0.285 0.255 1.000 4.000 1.000 3.4 1.20 1.52 0.070 0.094 0.005 0.087 17.775 17.990 17.094 GT1 1.805 0.13 1.075 0.275 0.285 0.255 0.																0	1									1.000	40							0.000								
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17.350   1	9 1											10.0	0.000			0			0.000							Program I									and the second	- S						8.5
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Lot 4   =   Q2 roofwater outside catchment boundary directed to kerb inside Catchment B			=	Add 4	00m2 to ar	ea of Calch	nment C (4	100m2@	0.7f = 3	10m2@	(n e)						-			_		2.5			<b>∄</b>	Ē	_ =		Ē	ž	Ĕ	ä	1 =	Ŧ	_				22			
Lot 4   =   Q2 roofwater outside catchment boundary directed to kerb inside Catchment B	Lot	3		Q2100	ofwater late	ral Inflow to	GT3										<u>ĝ</u>			ĕ	<b>岩</b>	* 4	1		동활	ğ	- <del>-</del> -	1		5	3	ž	5	Ē	18				Ž.			
Lot 4   =   Q2 roofwater outside catchment boundary directed to kerb inside Catchment B			(E)	(0.9*0	.85) * 123	0.0200/3	180										20				E 0	1 2		:   :	ģਊ	1	1 \$	- 5	3	Ξ	Ë	8	5	Ē	_				Ĕ			
Lot 4 = Q2 roofwater outside catchment boundary directed to kerb inside Catchment B  = Add 260m2 to area of Catchment 8 (260m2 (0.0 7ft = 200m2 (0.0 9ft))    Contained in Latinuary Contained Inside Catchment B   Contained in Latinuary Contained Inside Catchment B   Contained in Latinuary Contained Inside Catchment B   Contained Inside Catc				0.000	m3/s												ž			3	ē ē	= 8	1	,	បីថី				300	m3/s	_ <u></u>	7	3	=		>	-		ថ			
= Add 250m2 to area of Calchment 8 260m2 @ 0.7 ft = 200m2 @ 0.9 ft)  Use years of GT: 2 A-5 C C.5342 0.555 0.0057 120 C.115 C.C70 0.042 10 1.11m 0.052m Contained in Latitude  Containe	Lot	4	=	Q2100	ofwater out	ide catchr	nent bound	tary direc	ted to ke	to inside (	Calchmer	nt B			P.	-1 Fb	رو قاما روط			"		- ""	"				T			11015					"""							
			=	Add 2	90m2 to ar	ea of Cald	ment B (2	60m2 @	0.7fi = 2	00m2@	96)									.	4.5			3/15	1504	0.0057	. 22			0.070	2042	- 23	1.156	0.052/m			Cuelvin	e I al	alf coare			
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F	INFORMATION RESPONSE	04-09-13	P.E
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APPROVED: Janul Muchel DANIEL MICHEL RPEQ 3766 DIRECTOR HUNT MICHEL & PARTNERS

# BAIRD SHAYES SURVEYORS - TOWN PLANNERS

P.O BOX 867, IPSWICH Q. 4305 77 RODERICK STREET, IPSWICH "BARTLEFRERE" PH 3812 2076 FAX 3812 1614

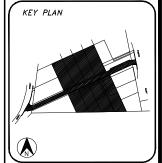BAIRD & HAYES

(Established 1946)

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For ALL yyellow 19510N

DEVELOPMENT APPLICATIONS

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#### RANDS DEVELOPMENT NO.2 Pty Ltd

PROJECT PROPOSED RECONFIGRATION
OF A LOT (LOT 6 INTO 6 LOTS
& NEW ROAD)


Of Lots 38-41 on RP30068 and Lots 9 & 101 on SP127089

BERRY STREET & PHOENIX COURT, CHURCHILL Padeb of FURGA County of CHURCHILL

Level Datum:	A.H.D. vide PSM 30887
Bench Mark	
Location:	Berry Street
Adopted Level:	18.632m AHD
Contour Interval:	0.25m


STORMWATER CATCHMENT PLAN & CALCULATIONS


DESIGNED:	P.E.		JOB No
DRAWN:		& B.F	9597
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			9597-33-

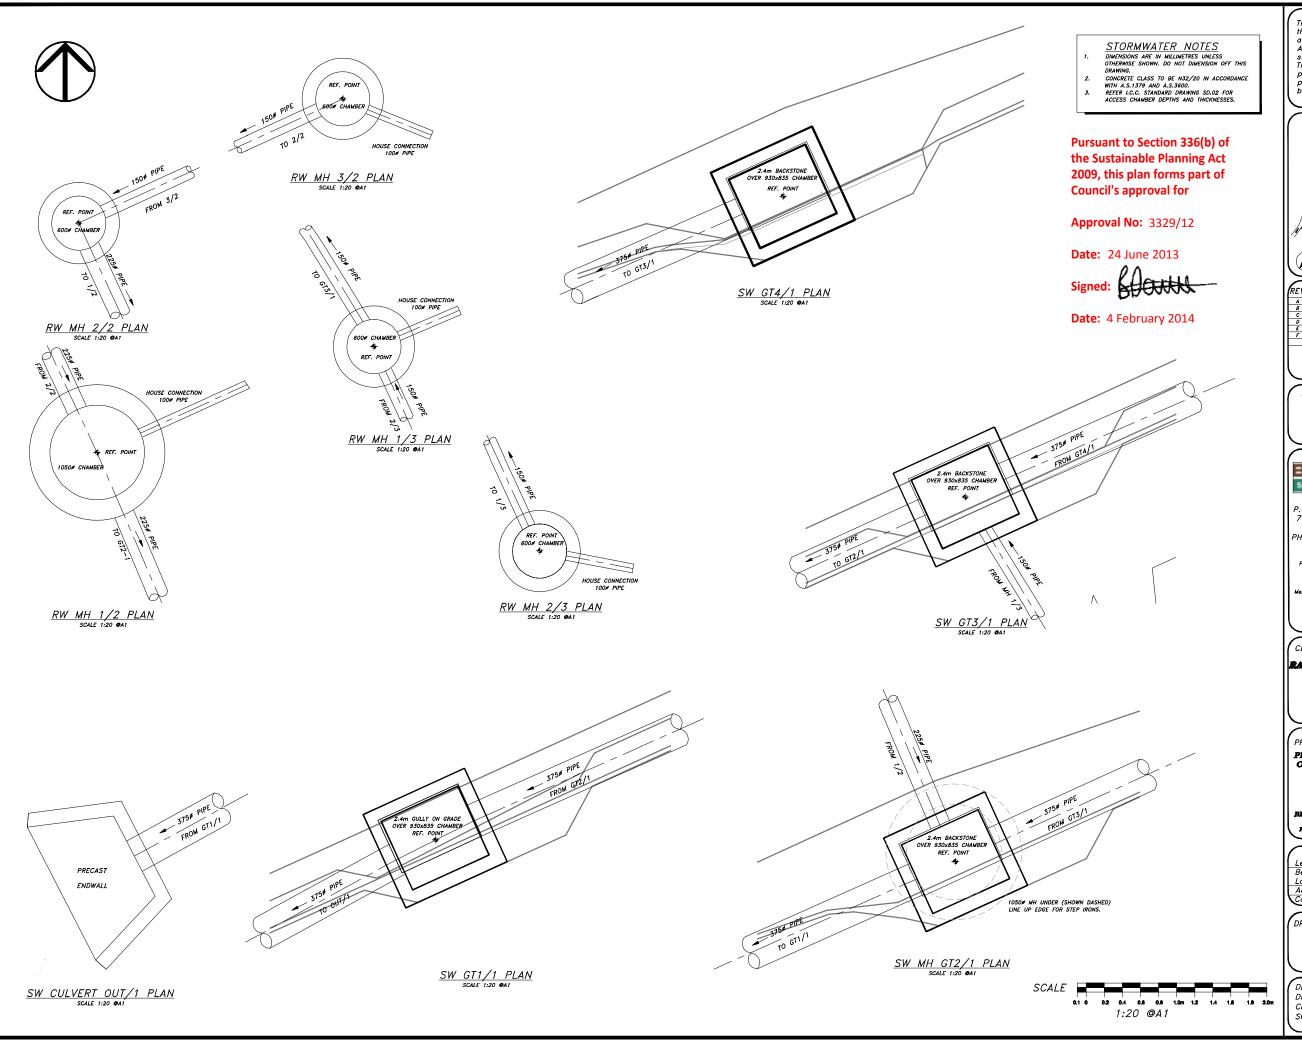

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KEY PLAN



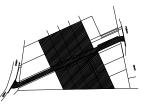

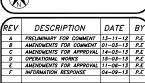APPROVED:

Janul Muchel DANIEL MICHEL RPEQ 3766 DIRECTOR HUNT MICHEL & PARTNERS

# BAIRD HAYES

P.O BOX 867, IPSWICH Q. 4305 77 RODERICK STREET, IPSWICH "BARTLEFRERE" PH 3812 2076 FAX 3812 1614

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# RANDS DEVELOPMENT NO.1

Pty Ltd

PROPOSED RECONFIGRATION OF A LOT (LOT 6 INTO 6 LOTS & NEW ROAD)

Of Lots 38-41 on RP30068 and Lots 9 & 101 on SP127089

BERRY STREET & PHOENIX COURT, CHURCHILL, Packet of FURGA County of CHURCHILL

Level Datum:	A.H.D. vide PSM 30887
Bench Mark	
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DRAWING TITLE

STORMWATER MANHOLE & GULLY DETAILS

DESIGNED:	P.E.	JOB No.
DRAWN:	C.R. & B.R.	9597
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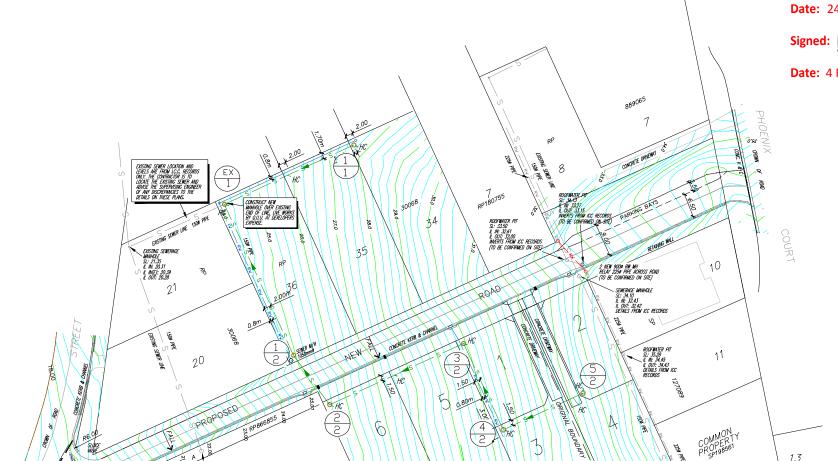
PROPOSED SEWER PIPE ----- S ----- S ---EXISTING SEWER PIPE DRAIN INVERT ROOFWATER PIPE CROWN OF ROAD DESIGN CONTOUR 1.0m DESIGN CONTOUR 0.25m HOUSE CONNECTION STRUCTURE NO. 2 PROPOSED ACCESS CHAMBER LEVEL

SEWERAGE RETICULATION NOTES

ALL CONSTRUCTION IS TO BE IN ACCORDANCE WITH I.C.C. PLANNING SCHEME "POLICY 3 — GENERAL WORKS" AND STANDARD DRAWINGS.

LINE NO

- 2. IT IS THE CONTRACTOR'S RESPONSIBILITY TO ASCERTAIN THE LOCATION AND DEPTH OF ALL PUBLIC UTILITIES WHICH MAY BE AFFECTED BY THIS PLAN PRIOR TO COMMENCING WORK.
- 3. ALL SEWERAGE CONSTRUCTION WORK UNDERTAKEN BY THE CONTRACTOR IS TO COMPLY WITH THE REQUIREMENTS OF THE QUEENSLAND WORKPLACE HEALTH AND SAFETY ACT.
- 4. THE CONTRACTOR TO VERIFY FINISHED SURFACE LEVELS ON SITE BEFORE CONSTRUCTION OF SEWERS AND HOUSE CONNECTION BRANCHES.
- 5. ALL WORK ASSOCIATED WITH LIVE SEWERS OR MANHOLES TO BE CARRIED OUT BY Q.U.U. AT DEVELOPER'S EXPENSE.
- 6. ALL ACCESS CHAMBERS ARE TO BE 1050\$\( \times\) PRECAST OR CAST-INSITU IN ACCORDANCE WITH ICC SS.03A AND SS.02A STANDARD DRAWINGS RESPECTIVELY. THE SURFACE LEVEL OF CHAMBERS ARE TO BE 50 TO 75mm HIGHER THAN SURROUNDING FINISHED SURFACE LEVELS. THE DESIGN FINISHED SURFACE LEVELS ONLY.
- 7. ALL HOUSE CONNECTION BRANCHES ARE TO EXTEND 600mm MIN INTO PROPERTY AND ARE TO BE CONSTRUCTED IN ACCORDANCE WITH ICC SS.10D STANDARD DRAWING.
- 8. END OF LINE MANHOLES ARE TO BE CONSTRUCTED IN ACCORDANCE WITH ICC STD DWG SS.24.
- 9. ALL HOUSE CONNECTION INVERT LEVELS AS SHOWN ON THESE DRAWINGS ARE THE HIGHEST POSSIBLE LEVEL TO CONTROL THE ALLOTMENT. ANY HOUSE CONNECTION LAID TO A HIGHER LEVEL SHALL BE RECTIFIED AT THE CONTRACTORS COST.
- 10. CONNECTION TO EXISTING MANHOLES ARE TO BE MADE BY Q.U.U UNLESS DIRECTED IN WRITING OTHERWISE BY Q.U.U.
- 11. ALL SEWER PIPES ARE TO BE U.P.V.C. CLASS SNB. 100mm HOUSE CONNECTION BRANCHES TO BE U.P.V.C. CLASS SN4.
- 12. ALL PIPE WORK IS TO BE TESTED TO THE SATISFACTION OF THE ENGINEER AND COUNCIL PRIOR TO CONNECTION TO THE COUNCIL MAINS.
- 13. ALL SEWER LINES TO BE PRESSURE TESTED WITH AIR. PRESSURE TEST TO 30kPa MIN AND HOLD FOR 3 MINUTES. PRESSURE MUST NOT FALL BELOW 25kPa IN 3 MINUTES.
- 14. COMPLY WITH ALL REQUIREMENTS OF THE SEWERAGE AND WATER SUPPLY ACT.



SEWERAGE PLAN

\$2.0

CH311618

SEWERAGE MANHOLE SL: 21.75 IL OUT: 20.70 (DETALS FROM COUNCIL RECORD

SEWER SETOUT M/H S/L EASTING NORTHING 1/1 27.65 5077.987 5097.625 24.08 | 5042.195 | 5081.220 EX/1 24.88 | 5061.301 | 5039.515 2/2 | 25.43 | 5071.311 | 5025.846 3/2 | 29.93 | 5108.289 | 5042.759 4/2 30.55 5119.277 5018.942 5/2 33.55 5141.310 5029.040

Pursuant to Section 336(b) of the Sustainable Planning Act 2009, this plan forms part of Council's approval for

**Approval No:** 3329/12

Date: 24 June 2013

Date: 4 February 2014

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APPROVED:

Janul Muchel DANIEL MICHEL RPEQ 3766 DIRECTOR HUNT MICHEL & PARTNERS

#### BAIRD HAYES SURVEYORS - TOWN PLANNERS

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# RANDS DEVELOPMENT NO.3

Ptv Ltd

PROPOSED RECONFIGRATION OF A LOT (LOT 6 INTO 6 LOTS & NEW ROAD)

> Of Lots 38-41 on RP30068 and Lots 9 & 101 on SP127089

BHRRY STREET & PHOENIX COURT, CHURCHILL, Packet of PURGA County of CHURCHILL

Level Datum:	A.H.D. vide PSM 30887
Bench Mark Location:	Berry Street
Adopted Level: Contour Interval:	18.632m AHD 0.25m

DRAWING TITLE

SEWERAGE PLAN

l	DESIGNED:	P.E.	JOB No.
	DRAWN:	C.R. & B.R	9597
l	CHECKED:	D.M.	DWG No.
	SCALE:	1:500@A1	9597-33-13

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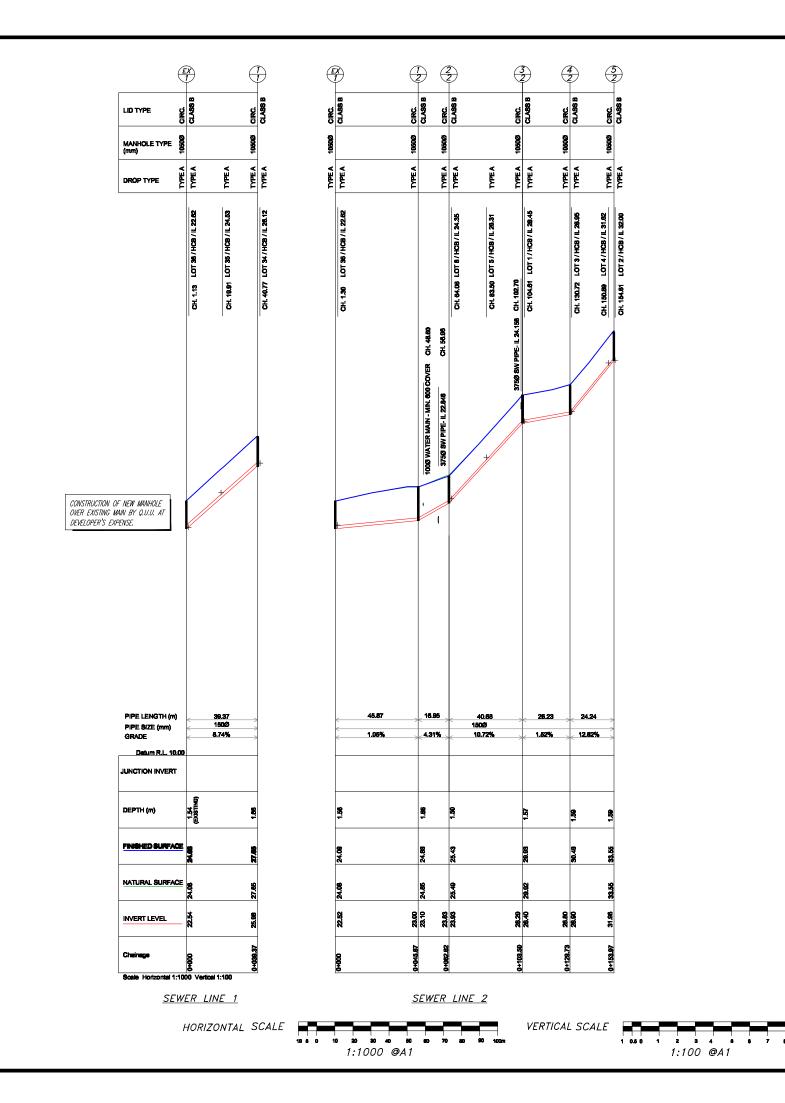


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PROPOSED RECONFIGRATION OF A LOT (LOT 6 INTO 6 LOTS & NEW ROAD)

Of Low 38-41 on RP30068 and Low 9 & 101 on SP127089

BERRY STREET & PHOENIX COURT, CHURCHILL Paths of FURGA County of CHURCHILL

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DRAWING TITLE

SEWERAGE LONGITUDINAL SECTIONS

DESIGNED:	P.E.	JOB No
DRAWN:	C.R. & B.R.	9597
CHECKED:	D.M.	DWG N
SCALE:	AS SHOWN	9597-33-



**LEGEND** 

WATER MAIN 1000	v v v
WATER CONDUIT 1000 PIPE	
EXISTING WATER PIPE	v v v
CONTOUR LINE 1.0m	-

WATER RETICULATION

1. ALL CONSTRUCTION TO BE IN ACCORDANCE WITH I.C.C. PLANNING SCHEME "POLICY 3 — GENERAL WORKS" AND STANDARD DWGS.

CONTOUR LINE 0.25m

- 2. WATERMAIN ALIGNMENT TO BE STRICTLY 2.5m FROM PROPERTY BOUNDARIES UNO.
- 3. ALL WATERMAINS SHALL HAVE 600mm MIN COVER (750mm FOR 200 AND 250% MAINS) UNDER FOOTPATHS, 900mm MIN COVER UNDER ROADWAYS (PROVIDE DICL MAINS IF 900 COVER CAN NOT BE ACHIÈVED).
- 4. BACKFILLING OF TRENCHES SHALL BE IN ACCORDANCE WITH ICC DRAWING SW.02A.
- 5. PIPES TO BE DICL CLASS K9 HEAVY CEMENT LINED OR UPVC CLASS 16 RUBBER RING JOINT SOCKET SPIGOT PIPE WITH DUCTILE IRON COMPATIBILITY O.D. TO BE MANUFACTURED IN ACCORDANCE WITH AS2977.1.
- 6. ALL FITTINGS TO BE CAST IRON OR DUCTILE IRON, CEMENT LINED, MINIMUM CLASS K9 AND TO BE MANUFACTURED AND TESTED IN ACCORDANCE WITH AS2280.
- 7. DUCTILE IRON PIPES AND FITTINGS TO BE SLEEVED IN POLYETHYLENE IN ACCORDANCE WITH AS3680 AND AS3681.
- B. THE CONTRACTOR IS TO OBTAIN TO LOCATION OF ALL EXISTING SERVICES AND PROTECT THESE PRIOR TO WORKING IN THE VICINITY. ANY DAMAGE IS TO BE REPAIRED AT THE
- 9. SLUICE VALVES ARE TO BE CAST IRON TO BE MANUFACTURED TO AS2638 AND BE CLASS 14 MINIMUM.
- 10.THRUST BLOCKS TO BE PROVIDED AT ALL BENDS, TEES AND DEAD ENDS.
- 11.ALL WATER SUPPLY BENDS AND FITTINGS TO BE LOCATED IN THE FOOTPATH.
- 12. HYDRANTS TO BE LOCATED AS NEAR AS POSSIBLE ON LINE WITH COMMON PROPERTY BOUNDARIES.
- 13. HYDRANTS TO BE LOCATED OVER HIGHEST OR LOWEST POINTS ON THE WATER MAIN. WATER MAIN TO BE RAISED OR LOWERED TO INDUCE HIGH OR LOW POINTS AT HYDRANTS IN SAGS AND AT END OF MAINS.
- 14. HYDRANTS AND VALVES AT TRUNCATIONS TO BE LOCATED AT OR BEFORE THE TRUNCATION POINTS. ALL HYDRANTS AND VALVES ARE TO BE LOCATED WITH MARKER STAKES AND INDICATORS IN ACCORDANCE WITH ICC SW.10A AND SW.11A.
- 15. MAXIMUM JOINT DEFLECTIONS TO BE IN ACCORDANCE WITH MANUFACTURER'S SPECIFICATIONS.
- 16. SERVICE CONDUITS TO BE 100 DIA. FRC CLASS X OR UPVC CLASS 12 PIPES OR EQUIVALENT.
- 17 CONNECTIONS INTO EXISTING WATER MAINS TO BE CONSTRUCTIONS INVOLVES THE CONSTRUCTION BY Q.U.U. AT DEVELOPER'S EXPENSE. THESE CONNECTIONS ARE TO BE 2m LONG AND THE NEW MAIN IS TO BE LAID IN LINE HORIZONTALLY AND VERTICALLY WITH THE EXISTING.
- 18. TEMPORARY WARNING SIGNS AND DEVICES TO BE ERECTED AS PER MAINS ROADS DEPARTMENT MANUAL OF UNIFORM TRAFFIC CONTROL DEVICES.
- 19. PRIOR TO BACKFILLING THE MAINS AND FITTINGS, THE SYSTEM TO BE EXPOSED FOR MEASURING AS CONSTRUCTED INFORMATION BY THE PRINCIPAL'S SURVEYOR.
- 20. PRIOR TO BACKFILLING THE WATER RETICULATION SYSTEM IS TO BE PRESSURE TESTED TO 1.2MPG AND HELD FOR A MINIMUM OF FIFTEEN MINUTES.


WATER RETICULATION FITTINGS		
FITTING No.	TYPE	QUANTITY.
1	100/11.25 BEND	2
2	100/22.5 BEND	1
3	100 VALVE	2
4	100 HYDRANT	3
5	100/45 BEND	2

Pursuant to Section 336(b) of the Sustainable Planning Act 2009, this plan forms part of Council's approval for

**Approval No:** 3329/12

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WATER RETICULATION PLAN


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APPROVED:

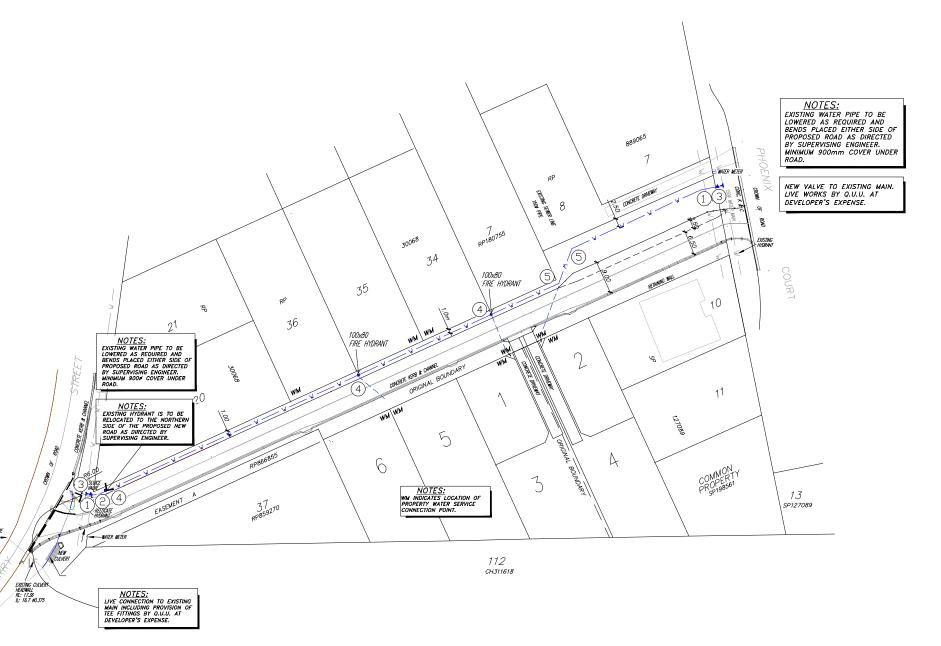Daniel Muchel DANIEL MICHEL RPEQ 3766 DIRECTOR HUNT MICHEL & PARTNERS

#### BAIRD 🖨 HAYES SURVEYORS - TOWN PLANNERS

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# RANDS DEVELOPMENT NO.2

Ptv Ltd
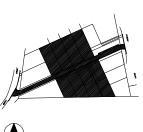
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Of Lots 38-41 on RP30068 and Lots 9 & 101 on SP127089


BERRY STREET & PHOENIX COURT, CHURCHILL
Paciets of PURGA County of CHURCHILL

Level Datum:	A.H.D. vide PSM 30887
Bench Mark Location:	Berry Street
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Contour Interval:	0.25m

DRAWING TITLE

WATER RETICULATION PLAN


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DRAWN:	C.R. & B.R.	9597
CHECKED:	D.M.	DWG No.
SCALE:	1:500@A1	9597-33-15

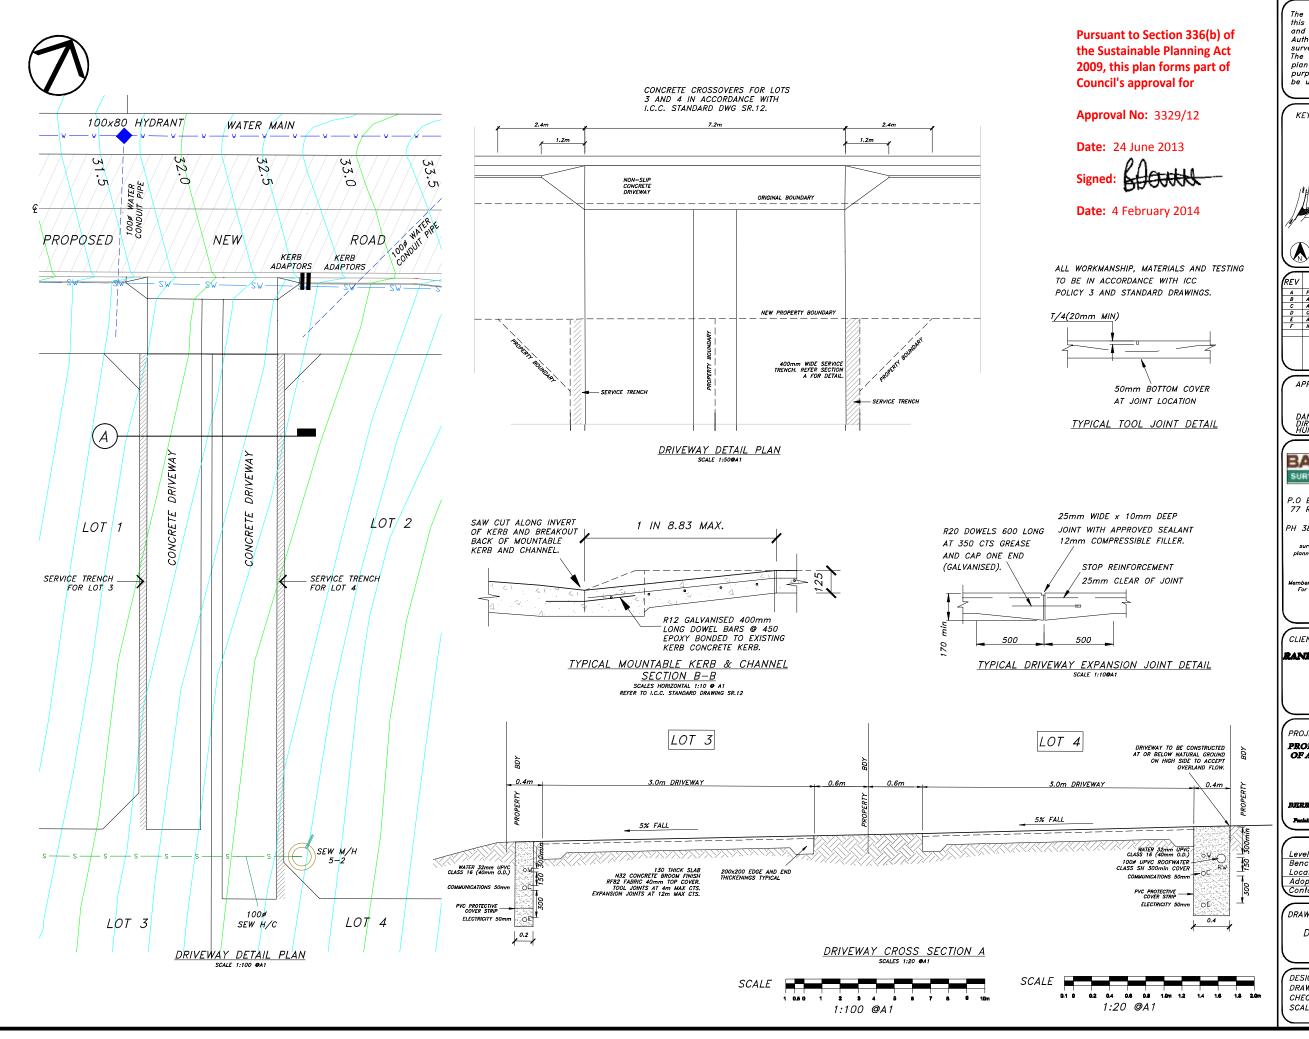

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DRAWING TITLE

DRIVEWAY PLAN AND DETAILS

DESIGNED:	P.E.	JOB No.
DRAWN:	C.R. & B.R.	9597
CHECKED:	D.M. AS SHOWN	DWG No.
SCALE:	AS SHOWN	9597-33-16

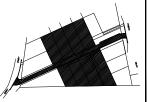

CONTOUR LINE 0.25m

PROPOSED ROAD SILT FENCE CONTOUR LINE 1.0m Pursuant to Section 336(b) of the Sustainable Planning Act 2009, this plan forms part of Council's approval for

**Approval No:** 3329/12

**Date:** 24 June 2013

Date: 4 February 2014

## SEDIMENT CONTROL NOTES

- THE CONTRACTOR IS TO TAKE ALL NECCESSARY PRECAUTIONS TO CONTROL EROSION AND DOWNSTREAM SEDIMENTATION DURING ALL STAGES OF CONSTRUCTION INCLUDING THE MAINTENANCE PERIOD.
- 2.ALL SEDIMENT CONTROL DEVICES SHALL BE MONITORED, CLEANED AND/OR REPAIRED WHENEVER THE ACCUMULATED SEDIMENT REDUCES THE CAPACITY BY 25%.
- 3.ALL PERIMETER BANK/SWALE SHALL HAVE UNINTERUPTED POSITIVE GRADE TO AN OUTLET.
- 4.AT ALL TIMES THE CONTRACTOR SHALL MONITOR THE PREVAILING WEATHER CONDITIONS AND PROTECT ANY DOWNSTREAM CONSTRUCTION AND GULLY INLETS.
- 5.ALL INLETS TO HAVE SILT PROTECTION BY PROVIDING PERIMETER SAND BAGS.
- 6.ALL AREAS OUTSIDE OF EXTENT OF WORKS ARE TO REMAIN UNDISTURBED.
- 7.ALL STOCKPILES CREATED ON SITE SHALL HAVE A SILT FENCE INSTALLED AT TOE OF DOWNSTREAM SIDE BATTER IMMEDIATELY AFTER PLACING OF THE STOCKPILE.

PHASE 1 CLEARING AND BULK EARTHWORKS
CONSTRUCT AND MAINTAIN SILT FENCES, SILT PONDS AND HAY BALES
WHICH CONTROL SEDIMENTATION AND EROSION DURING CLEARING AND
BULK EARTHWORKS.

 $\underline{\text{PHASE}}\ 2$  trench excavation construct and maintain slt fences which control sedimentation during trenching work.

## PHASE 3 PAVEMENT CONSTRUCTION

CONSTRUCT AND MAINTAIN SILT FENCES, GULLY INLET PROTECTION AND PIPE OUTLET PROTECTION WHICH CONTROL SEDIMENTATION AND EROSION DURING PAVEMENT CONSTRUCTION.

PHASE 4 MAINTENANCE PERIOD CONSTRUCT AND MAINTAIN SILT MANAGEMENT CONTROLS WHICH CONTROL SEDIMENTATION AND EROSION PRIOR TO THE ESTABLISHMENT OF GRASS COVER.

THE CONTRACTOR IS TO MONITOR SITE CONDITIONS AND PROVIDE ADDITIONAL EROSION CONTROL MEASURES WHERE REQUIRED. REFER TO I.C.C. STANDARD DRAWING SD.14 FOR CHECK DAM AND SEDIMENT TRAP DETAILS.

ALL DISTURBED AREAS TO BE TURFED OR HYDROMULCHED AS SOON AS PRACTICABLE AFTER COMPLETION OF EARTHWORKS.

STEEL OR WIRE MESH TO SUPPORT FILTER FABRIC. POSTS AT 2.0m CRS - TO BE STEEL
PICKETS OR MIN. 50x30mm
HARDWOOD. SEDIMENT CONTROL FABRIC FALL 200×200 V¶ TRENCH

SEDIMENT FENCE (SILT)

#### NOTES:

- 1.SEDIMENT FENCE TO BE INSTALLED ALONG A LINE OF CONSTANT GROUND ELEVATION WHEREVER PRACTICAL.
- 2.BOTHS ENDS OF THE SEDIMENT FENCE TO EXTEND UP THE SLOPE AT LEAST 1m. 3. SUPPOST POSTS TO BE SPACED A MAXIMUM 2m APART UNLESS THE FENCE IS SUPPORTED BY A TOP WIRE OR WIRE MESH BACKING, IN WHICH CASE 3m MAXIMUM SPACING.
- 4.FENCE 'RETURNS' SHALL BE INSTALLED AT MAXIMUM 20m SPACING IF FENCE IS INSTALLED ALONG THE CONTOUR, OTHERWISE 5 TO 10m MAXIMUM SPACING.
- 5. MINIMUM 4 STAPLES OR TIE WIRES PER STAKE.
- 6.REFER TO IECA AUSTRALASIA STANDARD DRAWINGS SF-01 AND SF-02 FOR ADDITIONAL NOTES AND DETAILS.




EROSION & SEDIMENT CONTROL PLAN

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Α	PRELIMINARY FOR COMMENT	13-11-12	P.1
В	AMENDMENTS FOR COMMENT	01-03-13	P.1
С	AMENDMENTS FOR APPROVAL	14-03-13	P.1
D	OPERATIONAL WORKS	15-03-13	P.1
Ε	AMENDMENTS FOR APPROVAL	11-06-13	P.E
F	INFORMATION RESPONSE	04-09-13	P.1
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APPROVED:

anul Muchel DANIEL MICHEL RPEQ 3766 DIRECTOR HUNT MICHEL & PARTNERS

### BAIRD 🤤 HAYES SURVEYORS . TOWN PLANNERS

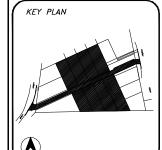P.O BOX 867, IPSWICH Q. 4305 77 RODERICK STREET, IPSWICH "BARTLEFRERE" PH 3812 2076 FAX 3812 1614

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RANDS DEVELOPMENT NO.2 Per Lui

PROPOSED RECONFIGRATION OF A LOT (LOT 6 INTO 6 LOTS & NEW ROAD)

Of Lon 38-41 vs RF30068 and Lots 9 & 161 on SP187089

BHRRY STREET & PEIGRNIX COURT; CHURCHILL Path of FURGA Comp of CHURCHILL

17	A.H.D. vide
Level Datum:	PSM 30887
Bench Mark	
Location:	Berry Street
Adopted Level:	18.632m AHD
Contour Interval:	0.25m

DRAWING TITLE

SEDIMENT & EROSION CONTROL PLAN

DESIGNED: DRAWN:	C.R. & B.R.	JOB No. 9597
CHECKED:	D.M.	DWG No.
SCALE:	1:500@A1	9597-33-17



1:500 @A1