#### **BUILDING INFORMATION**

GROUND FLOOR PITCHING HEIGHT(S) 2595 FIRST FLOOR PITCHING HEIGHT(S): 2450 FRAMES AND TRUSSES: STEEL ROOF PITCH (U.N.O.): 22.5° ELECTRICITY SUPPLY: 3-PHASE

RETICULATED SUPPLY GAS SUPPLY:

**ROOF MATERIAL: CONCRETE TILES** DARK ROOF COLOUR:

WIND DRIVEN ROOF VENTILATORS:

WALL MATERIAL **BRICK VENEER** 

WALL COLOUR: DARK

#### **INSULATION**

INSULATION TO BE INSTALLED IN ACCORDANCE WITH N.C.C. AND RELEVANT **AUSTRALIAN STANDARDS** 

SARKING UNDER ROOFING

R4.0 BATTS TO CEILING (EXCL. GARAGE, ALFRESCO & PATIO)

R2.0 BATTS TO EXTERIOR WALLS (EXCL. GARAGE)

WALL WRAP TO ENTIRE HOUSE

#### SITE & ENGINEERING INFORMATION

DESIGN WIND CLASSIFICATION: N2 SITE CLASSIFICATION: SLAB CLASSIFICATION: H1

SLAB TO BE 85mm THICK (U.N.O.) REINFORCED WITH SL82 MESH(T) (U.N.O.) OVER A 200µm WATERPROOF MEMBRANE ON A BED OF FREE DRAINING COARSE SAND (WHERE SPECIFIED)

PROVIDE BRICK CONTROL JOINTS IN ACCORDANCE WITH N.C.C. & AS 3700

ALL STEEL FRAMING TO BE DESIGNED TO AS 4100-1998 OR AS/NZS 4600-2018

### **BASIX AREAS**

CONDITIONED 176.77 UNCONDITIONED 16.15

#### **TOTAL FLOOR AREAS**

ALFRESCO 11.59 GARAGE 33.34 LIVING (FIRST FLOOR) 120.46 LIVING (GROUND FLOOR) 102.58 **PATIO** 1.98 269.95 m<sup>2</sup>

### SUSTAINABILITY COMMITMENTS | AGGRESSIVE SOIL REQUIREMENTS

#### WATER COMMITMENTS

3 STAR (> 7.5 BUT <= 9 L/MIN) SHOWER HEADS

**4 STAR TOILET SUITES** 4 STAR KITCHEN TAPS 5 STAR BATHROOM TAPS

183.92 m<sup>2</sup> TOTAL ROOF AREA

3070 L WATER TANK(S) MINIMUM CAPACITY 124.68 m<sup>2</sup> MINIMUM ROOF AREA TO TANK(S)

#### RAINWATER TANK(S) TO BE CONNECTED TO:

- AT LEAST ONE OUTDOOR TAP
- ALL TOILETS
- WASHING MACHINE

NO RETICULATED RECYCLED WATER SUPPLY

275 m<sup>2</sup> GARDEN/LAWN AREA

#### **ENERGY COMMITMENTS**

#### **HOT WATER SYSTEM**

- GAS CONTINUOUS FLOW - 6 STAR

#### **HEATING SYSTEM**

- 1-PHASE REVERSE CYCLE AIR CONDITIONING

EER 3.5 - 4.0

**COOLING SYSTEM** - 1-PHASE REVERSE CYCLE AIR CONDITIONING FFR 35-40

#### **VENTILATION (EXHAUST FANS)**

- AT LEAST ONE BATHROOM:
- DUCTED TO OUTSIDE AIR, MANUAL SWITCH ON/OFF
- KITCHEN RANGEHOOD:
- DUCTED TO OUTSIDE AIR, MANUAL ON/TIMER OFF
- LAUNDRY:
- DUCTED TO OUTSIDE AIR, MANUAL SWITCH ON/OFF

#### PRIMARY FLUORESCENT/LED LIGHTING INCLUDING COVER

- 5 BEDROOMS/STUDY, NON-DEDICATED
- 3 LIVING/DINING AREAS, NON-DEDICATED
- KITCHEN, NON-DEDICATED
- ALL BATHROOMS/TOILETS, NON-DEDICATED
- LAUNDRY, NON-DEDICATED
- ALL HALLWAYS, NON-DEDICATED

#### **NATURAL LIGHTING TO**

- KITCHEN
- 4 BATHROOM/TOILET

#### ALTERNATIVE ENERGY

#### OTHER

- GAS COOKTOP, NO OVEN
- FIXED OUTDOOR CLOTHESLINE BY BUILDER
- NO FIXED INDOOR CLOTHESLINE

#### **BASIX CERTIFICATE:**

- 1011193S (02 SEPTEMBER 2019)

PROVIDE ADDITIONAL STRUCTURAL REQUIREMENTS, DUE TO BUILDING IN AN 'AGGRESSIVE SOIL ENVIRONMENT'. THIS SHALL INCLUDE THE FOLLOWING:

- PROVIDE 25MPa CONCRETE TO THE PIERS AND FLOOR SLABS IN LIEU OF STANDARD
- PROVIDE HIGH IMPACT MEMBRANE BELOW THE FLOOR SLAB.
- PROVIDE A MIN. 50mm BLINDING LAYER OF SAND UNDERNEATH THE FLOOR STRUCTURE.
- PROVIDE POLYETHYLENE DAMP PROOF COURSE TO THE EXTERNAL WALLS IN LIEU OF STANDARD.
- USE EXPOSURE GRADE MORTAR BELOW DAMP PROOF COURSE IN LIEU OF STANDARD
- USE EXPOSURE GRADE BRICKWORK FROM OUR STANDARD RANGE BELOW THE DAMP PROOF COURSE.



**LOCATION MAP** 

EXHAUST FANS TO BE DUCTED TO EXTERNAL AIRSPACE VIA FACADE OR ROOF IN ACCORDANCE WITH THE REQUIREMENTS OF PART 3.8.7 OF THE NCC.



**CONSTRUCTION PLANS** DATE: 23/09/2019

**ESTIMATOR:** DRAFTER: DCP MKC

DRAFTING OFFICE:

**SYDNEY** 

© 2020 MCDONALD JONES COMMUNITIES PTY LTD (ACN 603 418 364). THIS DRAWING IS AN ORIGINAL ARTISTIC WORK WITHIN THE MEANING OF THE COPYRIGHT ACT 1968 (CTH). MCDONALD JONES COMMUNITIES PTY LTD IS THE OWNER OF COPYRIGHT IN THIS DRAWING. YOU HEREBY AGREE AND UNDERTAKE THAT YOU WILL NOT IN ANY WAY REPRODUCE, COPY, MODIFY, USE OR TAKE ADVANTAGE OF THE DRAWING TO BUILD A HOUSE BASED ON THIS PLAN (WHETHER IN WHOLE OR IN PART) WITHOUT THE PRIOR WRITTEN CONSENT OF MCDONALD JONES COMMUNITIES PTY LTD.



Ì		DRAWING	1	DRAWN
ı	3	FRAME AMENDED TO STEEL	DCP	2019.09.06
ı	4	FACADE REVISED TO STOCKLAND GUIDELINES	DCP	2019.09.10
ı	5	CONSTRUCTION PLANS	DCP	2019.09.23
ı	6	KORDON TERMITE TREATMENT NOTE ADDED	DCP	2019.09.26
ı	7	ENS VANITY UPGRADED	JNO	2020.04.14

Ì	CLIENT:	LOT No.:		
	COMPLETE BY MCDONALD	3138		
	ADDRESS:	DP No.:		
	64 BARRALLIER DRIVE	1230911		
ı	SUBURB:	POSTCODE:	COUNCIL:	SECTION No.:
	MARSDEN PARK	2765	BLACKTOWN CITY	N/A

	OR WITH EN CONCENT OF MODOWALD SOME COMMISSION FOR THE ETD.				
ш		HOUSE CODE:			
I F		H-CCHHWS10DA		A PF	
FACADE DESIGN:   FACADE CODE:   FACADE CODE:   F-CCHHWS10BTLYA		YA	R		
IΙ	SHEET TITLE:	SCALES:	SHEET No.:		
Ľ	COVER SHEET		1 / 20	L	

DO NOT SCALE DRAWINGS, USE FIGURED DIMENSIONS ONLY. CHECK AND VERIEY DIMENSIONS AND LEVELS RIOR TO THE COMMENCEMENT OF AN WORK. ALL DISCREPANCIES TO BE REPORTED TO THE DRAFTING OFFICE

REFER TO SHEET 1 (COVER SHEET) FOR ALL BUILDING INFORMATION REGARDING:

- SUSTAINABILITY REQUIREMENTS SITE CLASSIFICATION GENERAL BUILDING INFORMATION
- REFER TO WATER MANAGEMENT PLAN FOR

ALL ROOF COLLECTION, SURFACE DRAINAGE CONNECTIONS AND DISCHARGE

STORMWATER LAYOUT IS DIAGRAMMATIC ONLY AND SUBJECT TO CONTRACTORS RECOMMENDATIONS AND/OR ANY CONSTRUCTION CONSTRAINTS, ALL SURFACE WATER DRAINAGE BY BUILDER

CHARGED STORMWATER SYSTEM CANNOT BE USED FOR DISPOSAL OF DRIVEWAY OR OTHER SURFACE STORMWATER. CUSTOMER IS TO PROVIDE ALTERNATIVE DISCHARGE LINES IF DOWNPIPES ARE NOTED AS 'COP' ON PLAN. THE BUILDER PROVIDES CAPACIT FOR DISPOSAL OF ROOF COLLECTED STORMWATER ONLY AND TAKES NO RESPONSIBILITY FOR OVERFLOW OR DAMAGE TO PROPERTY IF CUSTOMER ADDS ADDITIONAL DISCHARGE LOADS TO EXISTING STANDARD PROVISIONS.

	WIND CLASSIFICATION	N2
	WITHIN 1 KM. OF BREAKING SALT WATER	NO
	WITHIN 100 M. OF SALT WATER	NO
	MINIMUM AHD FLOOR LEVEL APPLICABLE	NO
	SURVEY AREA	NEW
	LATITUDE	0° 00' 00" S
[	LONGITUDE	0° 00' 00" E
Ιſ	APPROX. IMPORT/EX	(PORT FILL

TONNAGE: 12.07m3 x 2.25 = 27.16t 27 TONNES OF EXPORT FILL

17.70m<sup>3</sup>

5.63m<sup>3</sup>

12.07m<sup>3</sup>

CUT VOLUME

FILL VOLUME

DIFFERENCE

+/- 100mm TOLERANCE TO NOMINATED FINISHED FLOOR LEVELS.

SITE WORKS INDICATIVE ONLY. THE LOCATIONS AND HEIGHTS OF ANY PROPOSED RETAINING WALLS / DROPPED EDGE BEAMS ARE SUBJECT TO ON-SITE CONDITIONS


#### AGGRESSIVE SOIL REQUIREMENTS SEE SHEET 1 (COVER SHEET) FOR DETAILS


#### AGGRESSIVE SOIL REQUIREMENTS

BELOW THE DAMP PROOF COURSE


PROVIDE ADDITIONAL STRUCTURAL REQUIREMENTS, DUE TO BUILDING IN AN 'AGGRESSIVE SOIL ENVIRONMENT'. THIS SHALL INCLUDE THE FOLLOWING:


- PROVIDE 25MPa CONCRETE TO THE PIERS AND FLOOR SLABS IN LIEU OF STANDARD
- PROVIDE HIGH IMPACT MEMBRANE BELOW THE FLOOR SLAB. PROVIDE A MIN. 50mm BLINDING LAYER OF SAND UNDERNEATH THE
- FLOOR STRUCTURE
- PROVIDE POLYETHYLENE DAMP PROOF COURSE TO THE EXTERNAL WALLS IN LIEU OF STANDARD. USE EXPOSURE GRADE MORTAR BELOW DAMP PROOF COURSE IN LIEU
- USE EXPOSURE GRADE BRICKWORK FROM OUR STANDARD RANGE

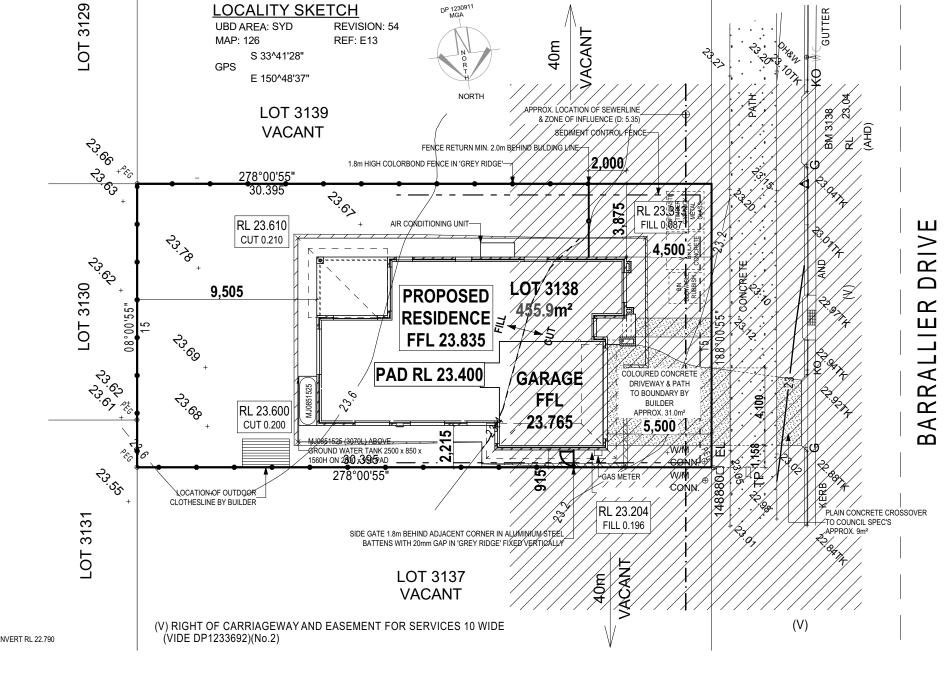


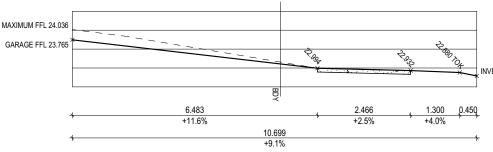

DHA (Up Profile with Footway)

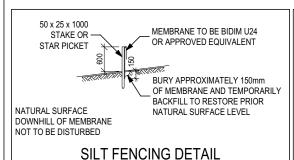

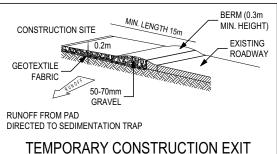

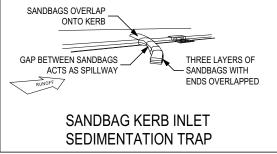

**CONSTRUCTION PLANS** DATE: 23/09/2019 **ESTIMATOR:** DRAFTER: MKC DRAFTING OFFICE: **SYDNEY** 

© 2020 MCDONALD JONES COMMUNITIES PTY LTD (ACN 603 418 364). THIS DRAWING IS AN ORIGINAL ARTISTIC WORK WITHIN THE MEANING OF THE COPYRIGHT ACT 1968 (CTH), MCDONALD JONES COMMUNITIES PTY LTD IS THE OWNER OF COPYRIGHT IN THIS DRAWING, YOU HEREBY AGREE AND UNDERTAKE THAT YOU WILL NOT IN ANY WAY REPRODUCE, COPY, MODIFY, USE OR TAKE ADVANTAGE OF THE DRAWING TO BUILD A HOUSE BASED ON THIS PLAN (WHETHER IN WHOLE OR IN PART) WITHOUT THE PRIOR WRITTEN CONSENT OF MCDONALD JONES COMMUNITIES PTY LTD.



		DRAWING	1	DRAWN
	3	FRAME AMENDED TO STEEL	DCP	2019.09.06
	4	FACADE REVISED TO STOCKLAND GUIDELINES	DCP	2019.09.10
	5	CONSTRUCTION PLANS	DCP	2019.09.23
	6	KORDON TERMITE TREATMENT NOTE ADDED	DCP	2019.09.26
	7	ENS VANITY UPGRADED	JNO	2020.04.14

	CLIENT:	LOT No.:		
3	COMPLETE BY MCDONALD	3138		
)	ADDRESS:	DP No.:		
3	64 BARRALLIER DRIVE	1230911		
3	SUBURB:	POSTCODE:	COUNCIL:	SECTION No.:
1	MARSDEN PARK	2765	BLACKTOWN CITY	N/A

HOUSE DESIGN:	HOUSE CODE:	ı
HEWITSON 29 H-CCHHWS10DA		
FACADE DESIGN: FACADE CODE:		
BENTLEIGH F-CCHHWS10BTLYA		.YA
SHEET TITLE:	SCALES:	SHEET No.:
SITE PLAN	1:200	2 / 20

DO NOT SCALE DRAWINGS, USE FIGURED DIMENSIONS ONLY. CHECK AND VERIEY DIMENSIONS AND LEVELS RIOR TO THE COMMENCEMENT OF AN WORK. ALL DISCREPANCIES TO BE REPORTED TO THE DRAFTING OFFICE

PATIO CEILING HEIGHT TO MATCH

ALFRESCO CEILING HEIGHT TO MATCH DWELLING INTERNAL

WET AREAS TO BE SETDOWN Omm FROM MAIN HOUSE SLAB

GENERAL BUILDING INFORMATION CDP CHARGED DOWNPIPE DIRECTED TO TANK STANDARD DOWNPIPE DIRECTED

TO STORMWATER DISCHARGE FIRE RESISTANT PLASTERBOARD TO BE INSTALLED BEHIND COOKTOP

ENSURE VERTICAL DPC FLASHING TO END OF GARAGE VENEER WALLS

ALL EXTERIOR STEPS AND LANDINGS BY BUILDER UNLESS NOTED OTHERWISE

ALL GROUND FLOOR BULKHEAD AND SQUARE SET OPENING FRAMES TO BE 2455 ABOVE FFL UNLESS NOTED OTHERWISE

ALL GROUND FLOOR INTERNAL DOORS TO BE 2340 HIGH UNLESS NOTED OTHERWISE

REFER TO WINDOW & DOOR SCHEDULES FOR FULL DETAILS OF ALL WINDOWS AND

ALL STAIR TREADS TO PROVIDE A MINIMUM SLIP RESISTANCE TO MEET NCC 3.9.1 REQUIREMENTS

UNLESS NOTED OTHERWISE ALL ROOMS ARE REFERENCED



# AGGRESSIVE SOIL REQUIREMENTS

SEE SHEET 1 (COVER SHEET) FOR DETAILS

KORDON TERMITE BARRIER TO BE INSTALLED TO ALL EXTERNAL WALLS IN ACCORDANCE WITH THE REQUIREMENTS OF PART 3.1.4 OF THE NCC.


PROVIDE AND INSTALL SINGLE PHASE REVERSE CYCLE AIR CONDITIONING SYSTEM. NUMBER AND POSITIONING OF OUTLETS AND THE FINAL LOCATION OF THE RETURN AIR GRILLE WILL BE DETERMINED ON SITE BY THE AIR CONDITIONING CONTRACTOR AND IS SUBJECT TO TRUSS LAYOUT AND ANY OTHER CONSTRUCTION CONSTRAINTS.


FRAME MANUFACTURER TO PROVIDE CLEARANCE FOR PASSAGE OF FAN COIL UNIT FROM RETURN AIR OPENING TO FINAL FAN COIL LOCATION

ANY PART OF THE FASCIA, GUTTERING OR DOWNPIPE THAT IS WITHIN 450mm OF ANY BOUNDARY IS TO BE NON-COMBUSTIBLE IN ACCORDANCE WITH THE REQUIREMENTS OF PART 3.7.1.7(c) OF THE NCC.

ALL ALFRESCO SLABS TO BE GRADED BY CONCRETER TO ACHIEVE APPROX. 1:100 FALL TO OUTSIDE EDGE WITH MAXIMUM CROSSFALL OF 30mn OVER ENTIRE SLAB (DOES NOT APPLY TO VERANDAH / PATIO / PORCH SLABS).

EXHAUST FANS TO BE DUCTED TO EXTERNAL AIRSPACE VIA FACADE OR ROOF IN ACCORDANCE WITH THE REQUIREMENTS OF PART 3.8.7 OF THE NCC

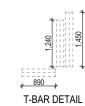

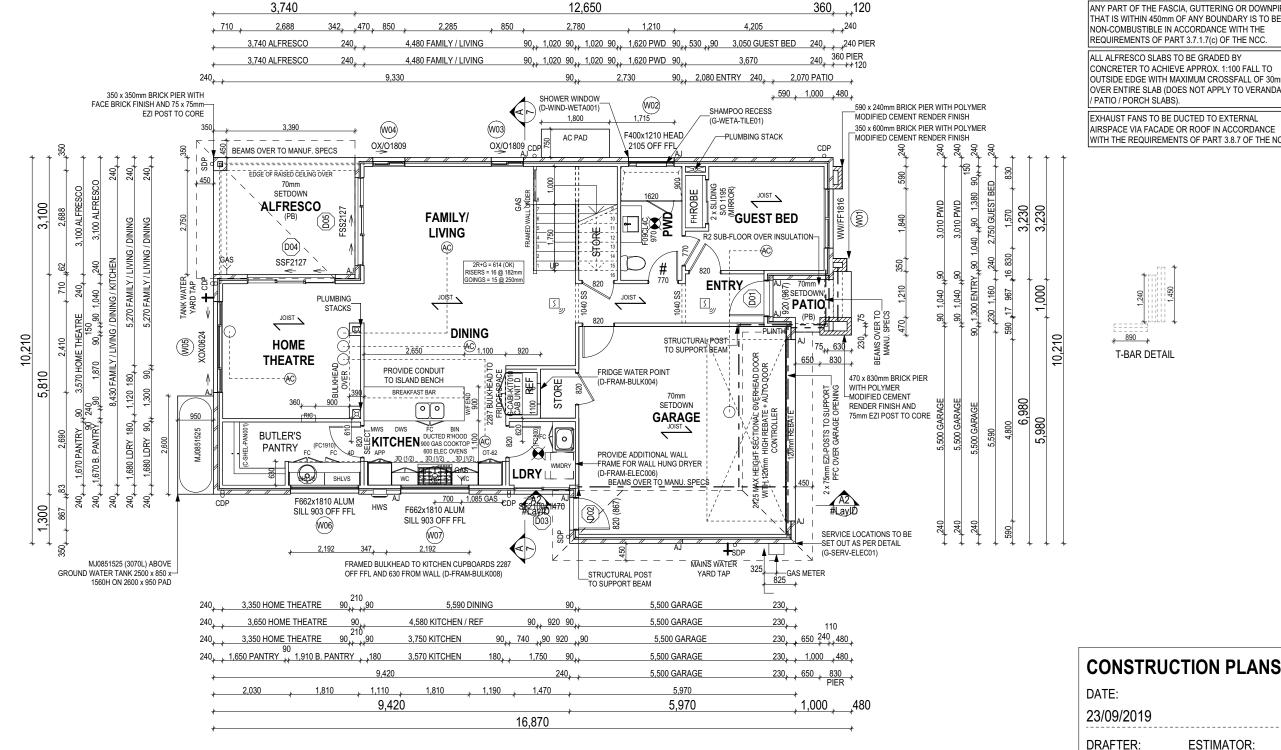

# FLOOR PLAN LEGEND

HOB SPOUT / WALL SPOUT FACE BRICK / COMMON BRICK HEBEI

SOUND INSULATION BRICK ARTICULATION JOINT DENOTES DRAWER SIDE

**FXHAUST FAN** LOAD BEARING WALL L.B.W

THIS DOOR OPENS FIRST SMOKE ALARM

# LIFT OFF HINGE WATER POINT

GAS BAYONET

FRIDGE WATER POINT

ALL DIMENSIONS ARE FRAME DIMENSIONS

© 2020 MCDONALD JONES COMMUNITIES PTY LTD (ACN 603 418 364). THIS DRAWING IS AN ORIGINAL ARTISTIC WORK WITHIN THE MEANING OF THE COPYRIGHT ACT 1968 (CTH), MCDONALD JONES COMMUNITIES PTY LTD IS THE OWNER OF COPYRIGHT IN THIS DRAWING, YOU HEREBY AGREE AND UNDERTAKE THAT YOU WILL NOT IN ANY WAY REPRODUCE, COPY, MODIFY, USE OR TAKE ADVANTAGE OF THE DRAWING TO BUILD A HOUSE BASED ON THIS PLAN (WHETHER IN WHOLE OR IN PART) WITHOUT THE PRIOR WRITTEN CONSENT OF MCDONALD JONES COMMUNITIES PTY LTD.

**Acomplete** 

		DRAWING	- 1	DRAWN
	3	FRAME AMENDED TO STEEL	DCP	2019.09.0
	4	FACADE REVISED TO STOCKLAND GUIDELINES	DCP	2019.09.1
	5	CONSTRUCTION PLANS	DCP	2019.09.2
	6	KORDON TERMITE TREATMENT NOTE ADDED	DCP	2019.09.2
	7	ENS VANITY UPGRADED	JNO	2020.04.1

ı	CLIENT:	LOT No.:		
6	COMPLETE BY MCDONALD	3138		
0	ADDRESS:	DP No.:		
3	64 BARRALLIER DRIVE	1230911		
6	SUBURB:	POSTCODE:	COUNCIL:	SECTION No.:
4	MARSDEN PARK	2765	BLACKTOWN CITY	N/A

HOUSE DESIGN:	HOUSE CODE:	
HEWITSON 29 H-CCHHWS10DA		
FACADE DESIGN: FACADE CODE:		
BENTLEIGH F-CCHHWS10BTL		.YA
SHEET TITLE:	SCALES:	SHEET No.:
GROUND FLOOR PLAN	1:100	4 / 20

DO NOT SCALE DRAWINGS, USE FIGURED DIMENSIONS ONLY. CHECK AND VERIEY DIMENSIONS AND LEVELS RIOR TO THE COMMENCEMENT OF AN WORK. ALL DISCREPANCIES TO BE REPORTED TO THE DRAFTING OFFICE

**ESTIMATOR:** 

MKC

DRAFTER:

**SYDNEY** 

DRAFTING OFFICE:

SUSTAINABILITY REQUIREMENTS SITE CLASSIFICATION GENERAL BUILDING INFORMATION

CDP CHARGED DOWNPIPE DIRECTED TO TANK STANDARD DOWNPIPE DIRECTED

TO STORMWATER DISCHARGE FIRE RESISTANT PLASTERBOARD TO BE INSTALLED BEHIND COOKTOP

ENSURE VERTICAL DPC FLASHING TO END OF GARAGE VENEER WALLS

ALL EXTERIOR STEPS AND LANDINGS BY CUSTOMER UNLESS NOTED OTHERWISE

ALL FIRST FLOOR BULKHEAD AND SQUARE SET OPENING FRAMES TO BE 2155 ABOVE FFL UNLESS NOTED OTHERWISE

REFER TO WINDOW & DOOR SCHEDULES FOR FULL DETAILS OF ALL WINDOWS AND

ALL STAIR TREADS TO PROVIDE A MINIMUM SLIP RESISTANCE TO MEET NCC 3.9.1 REQUIREMENTS

FIRST FLOOR WINDOW OPENINGS TO BE RESTRICTED AS REQUIRED BY NCC D2.24 (VOLUME ONE) AND/OR NCC 3.9.2.5 (VOLUME

PROVIDE FLOOR WASTE AND OVERFLOW SPITTERS TO UPPER FLOOR TANKED BALCONIES WHERE APPLICABLE AS PER:

FLOOR PLAN LEGEND

HOB SPOUT / WALL SPOUT FACE BRICK / COMMON BRICK SOUND INSULATION

BRICK ARTICULATION JOINT DENOTES DRAWER SIDE

**FXHAUST FAN** 

SMOKE ALARM

LIFT OFF HINGE WATER POINT

GAS BAYONET

FRIDGE WATER POINT

L.B.W

#

LOAD BEARING WALL

THIS DOOR OPENS FIRST

G-FACA-BALC02 (PFC/BRICKWORK) G-FRAM-BALC001 (LIGHTWEIGHT CLADDING)


UNLESS NOTED OTHERWISE ALL ROOMS ARE REFERENCED AS FOLLOWS:



# SEE SHEET 1 (COVER SHEET) FOR DETAILS

AGGRESSIVE SOIL REQUIREMENTS

3,590 12,650 1,570 1,070 1,570 , 620 , 1,210 240, 1,350 WIR 2 , 90 2,950 BED 2 90<sub>kk</sub> 2,220 STAIRWELL 90<sub>kk</sub> 1,500 ENS , 180 3,700 MASTER SUITE 1.820

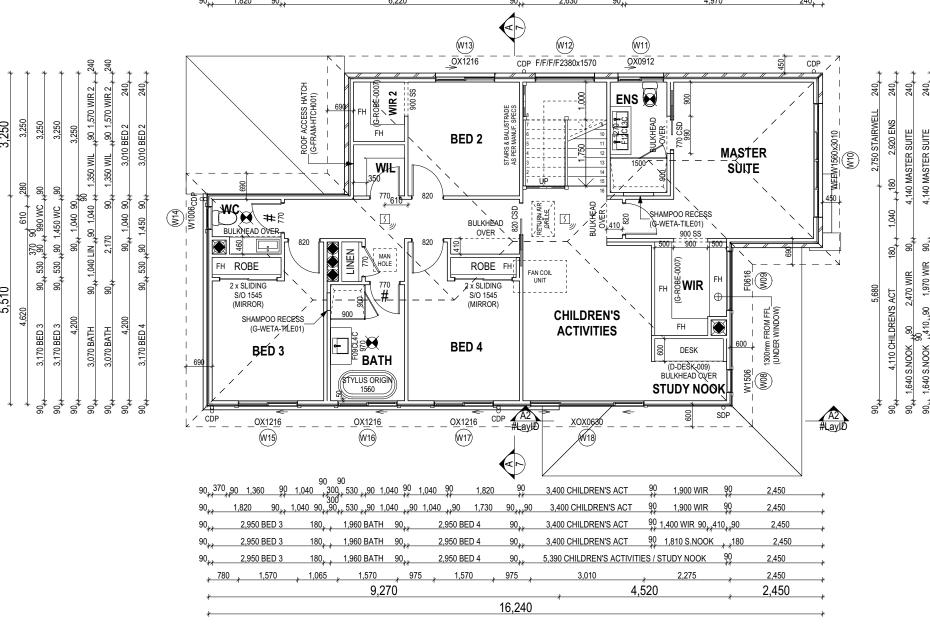

ALL DIMENSIONS ARE FRAME DIMENSIONS © 2020 MCDONALD JONES COMMUNITIES PTY LTD (ACN 603 418 364). THIS DRAWING IS AN ORIGINAL ARTISTIC WORK WITHIN THE MEANING OF THE COPYRIGHT ACT 1968 (CTH). MCDONALD JONES COMMUNITIES PTY LTD IS THE OWNER OF COPYRIGHT IN THIS DRAWING. YOU HEREBY AGREE AND UNDERTAKE THAT YOU WILL NOT IN ANY WAY REPRODUCE, COPY, MODIFY, USE OR TAKE ADVANTAGE OF THE DRAWING TO BUILD A HOUSE BASED ON THIS PLAN (WHETHER IN WHOLE OR IN PART) WITHOUT THE PRIOR WRITTEN CONSENT OF MCDONALD JONES COMMUNITIES PTY LTD.

Acomplete

Ì		DRAWING	ı	DRAWN
	3	FRAME AMENDED TO STEEL	DCP	2019.09.06
	4	FACADE REVISED TO STOCKLAND GUIDELINES	DCP	2019.09.10
	5	CONSTRUCTION PLANS	DCP	2019.09.23
	6	KORDON TERMITE TREATMENT NOTE ADDED	DCP	2019.09.26
	7	ENS VANITY UPGRADED	JNO	2020.04.14

	CLIENT:	LOT No.:		
06	COMPLETE BY MCDONALD	3138		
.10	ADDRESS:	DP No.:		
23	64 BARRALLIER DRIVE	1230911		
26	SUBURB:	SECTION No.:		
.14	MARSDEN PARK	2765	BLACKTOWN CITY	N/A

OUSE DESIGN:	HOUSE CODE:			
IEWITSON 29	H-CCHHWS10DA			
ACADE DESIGN:	FACADE CODE:			
SENTLEIGH F-CCHHWS10BTL				
HEET TITLE:	SCALES:	SHEET No.:		
IRST FLOOR PLAN	1:100	5 / 20		

EXTERNAL WALLS IN ACCORDANCE WITH THE

REQUIREMENTS OF PART 3.1.4 OF THE NCC.

,140 MASTER SUITE

8,760

90

140

610

4,140

KORDON TERMITE BARRIER TO BE INSTALLED TO ALL PROVIDE AND INSTALL SINGLE PHASE REVERSE CYCLE AIR CONDITIONING SYSTEM. NUMBER AND POSITIONING OF OUTLETS AND THE FINAL LOCATION OF THE RETURN AIR GRILLE WILL BE DETERMINED ON SITE BY THE AIR CONDITIONING CONTRACTOR AND IS SUBJECT TO TRUSS LAYOUT AND ANY OTHER CONSTRUCTION CONSTRAINTS.

> FRAME MANUFACTURER TO PROVIDE CLEARANCE FOR PASSAGE OF FAN COIL UNIT FROM RETURN AIR OPENING TO FINAL FAN COIL LOCATION.

ANY PART OF THE FASCIA, GUTTERING OR DOWNPIPE THAT IS WITHIN 450mm OF ANY BOUNDARY IS TO BE NON-COMBUSTIBLE IN ACCORDANCE WITH THE REQUIREMENTS OF PART 3.7.1.7(c) OF THE NCC.

ALL ALFRESCO SLABS TO BE GRADED BY CONCRETER TO ACHIEVE APPROX. 1:100 FALL TO OUTSIDE EDGE WITH MAXIMUM CROSSFALL OF 30mn OVER ENTIRE SLAB (DOES NOT APPLY TO VERANDAH / PATIO / PORCH SLABS).

**CONSTRUCTION PLANS** 

DATE: 23/09/2019

**ESTIMATOR:** DRAFTER:

MKC

DRAFTING OFFICE:

**SYDNEY** 

DO NOT SCALE DRAWINGS, USE FIGURED DIMENSIONS ONLY. CHECK AND VERIFY DIMENSIONS AND LEVELS PRIOR TO THE COMMENCEMENT OF AN WORK. ALL DISCREPANCIES TO BE REPORTED TO THE DRAFTING OFFICE

1, 2 ASSUME LOOKING FROM INSIDE

0,3 ASSUME LOOKING FROM OUTSIDE	1, 2 ASSUME LOOKING FE	ROM INSIDE									
ID CODE°	ROOM	HEIGHT	WIDTH	PERIMETER	AREA FRAME (m²) TYPE	BAL RATING	SILL TYPE	ORIENT.	GLAZING AREA (m²)	ADDITIONAL INFORMATION <sup>3</sup>	
W01 WW/FF1816	GUEST BED	1,800	1,570	6,740	2.83 ALUMINIUM	N/A	SNAP HEADER	W	2.17 CLEAR	BP 620, MP 785/785	
W02 F400x1210	PWD	400	1,210	3,220	0.48 ALUMINIUM	N/A	SNAP HEADER	S	0.37 OBSCURE, TOUGHENED		
W03 OX/O1809	FAMILY / LIVING	1,800	850	5,300	1.53 ALUMINIUM	N/A	SNAP HEADER	S	1.24 CLEAR	BP 620	
W04 OX/O1809	FAMILY / LIVING	1,800	850	5,300	1.53 ALUMINIUM	N/A	SNAP HEADER	S	1.24 CLEAR	BP 620	
W05 XOX0624	HOME THEATRE	600	2,410	6,020	1.45 ALUMINIUM	N/A	SNAP HEADER	E	1.19 CLEAR		
W06 F662x1810	BUTLER'S PANTRY	662	1,810	4,944	1.20 ALUMINIUM	N/A	SNAP HEADER	N	1.03 CLEAR, TOUGHENED		
W07 F662x1810	KITCHEN	662	1,810	4,944	1.20 ALUMINIUM	N/A	SNAP HEADER	N	1.03 CLEAR, TOUGHENED		
W08 W1506	STUDY NOOK	1,460	610	4,140	0.89 ALUMINIUM	N/A	NONE	W	0.64 CLEAR, TOUGHENED		
W09 F0616	WIR	600	1,570	4,340	0.94 ALUMINIUM	N/A	NONE	W	0.79 OBSCURE, TOUGHENED		
W10 WFFW1560x3010	MASTER SUITE	1,560	3,010	9,140	4.70 ALUMINIUM	N/A	SNAP HEADER	W	3.82 CLEAR, TOUGHENED	MP 753-753	
W11 OX0912	ENS	860	1,210	4,140	1.04 ALUMINIUM	N/A	SNAP HEADER	S	0.86 OBSCURE, TOUGHENED		
W12 F/F/F/F2380x1570	STAIRWELL	2,380	1,570	7,900	3.74 ALUMINIUM	N/A	SNAP HEADER	S	3.13 CLEAR, TOUGHENED	BP 595/1190/1785	
W13 OX1216	BED 2	1,200	1,570	5,540	1.88 ALUMINIUM	N/A	SNAP HEADER	S	1.64 CLEAR, TOUGHENED		
W14 W1006	WC	1,030	610	3,280	0.63 ALUMINIUM	N/A	NONE	Е	0.44 OBSCURE, TOUGHENED		
W15 OX1216	BED 3	1,200	1,570	5,540	1.88 ALUMINIUM	N/A	NONE	N	1.64 CLEAR, TOUGHENED		
W16 OX1216	BATH	1,200	1,570	5,540	1.88 ALUMINIUM	N/A	NONE	N	1.64 OBSCURE, TOUGHENED		
W17 OX1216	BED 4	1,200	1,570	5,540	1.88 ALUMINIUM	N/A	NONE	N	1.64 CLEAR, TOUGHENED		
W18 XOX0630	CHILDREN'S ACTIVITIES	600	3,010	7,220	1.81 ALUMINIUM	N/A	NONE	N	1.51 CLEAR, TOUGHENED		
					31.49				26.02		

#### **EXTERIOR DOOR SCHEDULE**

0,1 ASSUME LOOKING FROM OUTSIDE

ID	CODEº	ROOM	HEIGHT	WIDTH	AREA FRAME (m²) TYPE	BAL RATING	SILL TYPE	ORIENT.	GLAZING	DOOR TYPE ADDITIONAL INFORMATION¹
D01	920	ENTRY	2,106	967	2.04 TIMBER	N/A	SNAP HEADER	W	DOOR(S): CLEAR - SIDELIGHT(S): N/A	SWINGING
D02	820	GARAGE	2,106	867	1.83 TIMBER	N/A	SNAP HEADER	Е	DOOR(S): N/A - SIDELIGHT(S): N/A	SWINGING
D03	SF2100x1470	LDRY	2,100	1,470	3.09 ALUMINIUM	N/A	SNAP HEADER	N	CLEAR, TOUGHENED	SLIDING
D04	SSF2127	HOME THEATRE	2,100	2,688	5.64 ALUMINIUM	N/A	SNAP HEADER	S	CLEAR, TOUGHENED	STACKER
D05	FSS2127	FAMILY / LIVING	2,100	2,688	5.64 ALUMINIUM	N/A	SNAP HEADER	E	CLEAR, TOUGHENED	STACKER

18.24 m²

#### INTERIOR DOOR SCHEDULE

QTY	CODE	TYPE	HEIGHT	WIDTH	GLAZING	ADDITIONAL INFORMATION
2	1040 SS	SQUARE SET OPENING	2,455	1,040	N/A	
2	2 x SLIDING	SLIDING	2,040	1,530	N/A	SELECT
1	2 x SLIDING	SLIDING	2,340	1,180	N/A	SELECT
2	770	SWINGING	2,040	770	N/A	
2	770	SWINGING	2,040	770	N/A	LIFT-OFF HINGES
1	770	SWINGING	2,340	770	N/A	
1	770	SWINGING	2,340	770	N/A	LIFT-OFF HINGES
1	770 CSD	CAVITY SLIDING	2,040	770	N/A	
4	820	SWINGING	2,040	820	N/A	
5	820	SWINGING	2,340	820	N/A	
1	820	SWINGING	2,340	820	TRANSLUCENT	SELECT
1	820 CSD	CAVITY SLIDING	2,040	820	N/A	
2	900 SS	SQUARE SET OPENING	2,155	900	N/A	

### PICTURE / TV RECESS & SQUARE SET WINDOW SCHEDULE

QTY TYPE HEIGHT WIDTH AREA (m²)

> REFER TO SHEET 1 (COVER SHEET) FOR ALL BUILDING INFORMATION REGARDING: SUSTAINABILITY REQUIREMENTS - SITE CLASSIFICATION
> - GENERAL BUILDING INFORMATION

# **CONSTRUCTION PLANS**

DATE: 23/09/2019

DRAFTER:

SYDNEY

**ESTIMATOR:** 

DRAFTING OFFICE:

© 2020 MCDONALD JONES COMMUNITIES PTY LTD (ACN 603 418 364). THIS DRAWING IS AN ORIGINAL ARTISTIC WORK WITHIN THE MEANING OF THE COPYRIGHT ACT 1968 (CTH). MCDONALD JONES COMMUNITIES PTY LTD IS THE OWNER OF COPYRIGHT IN THIS DRAWING. YOU HEREBY AGREE AND UNDERTAKE THAT YOU WILL NOT IN ANY WAY REPRODUCE, COPY, MODIFY, USE OR TAKE ADVANTAGE OF THE DRAWING TO BUILD A HOUSE BASED ON THIS PLAN (WHETHER IN WHOLE OR IN PART) WITHOUT THE PRIOR WRITTEN CONSENT OF MCDONALD JONES COMMUNITIES PTY LTD.



Ì		DRAWING	ı	DRAWN
	3	FRAME AMENDED TO STEEL	DCP	2019.09.06
	4	FACADE REVISED TO STOCKLAND GUIDELINES	DCP	2019.09.10
	5	CONSTRUCTION PLANS	DCP	2019.09.23
	6	KORDON TERMITE TREATMENT NOTE ADDED	DCP	2019.09.26
	7	ENS VANITY UPGRADED	JNO	2020.04.14


	CLIENT:	LOT No.:							
9.06	COMPLETE BY MCDONALD JONES								
9.10	ADDRESS:	DP No.:							
9.23	64 BARRALLIER DRIVE			1230911					
9.26	SUBURB:	POSTCODE:	COUNCIL:	SECTION No.:					
1.14	MARSDEN PARK	2765	BLACKTOWN CITY	N/A					

_					
ı	HOUSE DESIGN:	HOUSE CODE:			
	HEWITSON 29	H-CCHHWS10DA			
	FACADE DESIGN:	FACADE CODE:			
	BENTLEIGH	F-CCHHWS10BTL	YΑ		
1	SHEET TITLE:	SCALES:	SHEET No.:		
	WINDOW & DOOR SCHEDULES		6 / 20		

DO NOT SCALE DRAWINGS, USE FIGURED DIMENSIONS ONLY. CHECK AND VERIFY DIMENSIONS AND LEVELS PRIOR TO THE COMMENCEMENT OF ANY WORK. ALL DISCREPANCIES TO BE REPORTED TO THE DRAFTING OFFICE.


FIRST FLOOR WINDOW OPENINGS TO BE RESTRICTED AS REQUIRED BY NCC D2.24 (VOLUME ONE) AND/OR NCC 3.9.2.5 (VOLUME

#### AGGRESSIVE SOIL REQUIREMENTS SEE SHEET 1 (COVER SHEET) FOR DETAILS

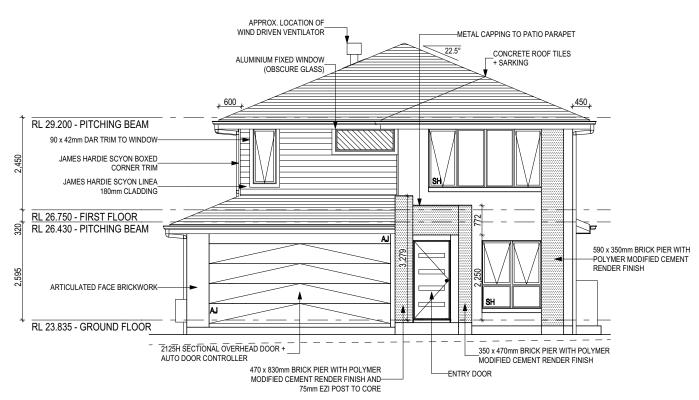


## FRONT ELEVATION


Scale: 1:100

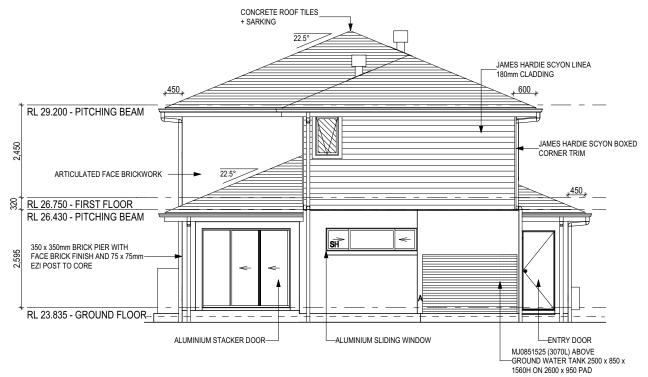

**REAR ELEVATION** Scale: 1:100

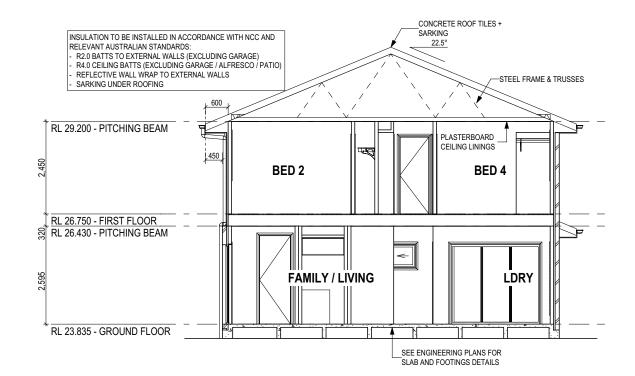

**SECTION A-A** Scale: 1:100

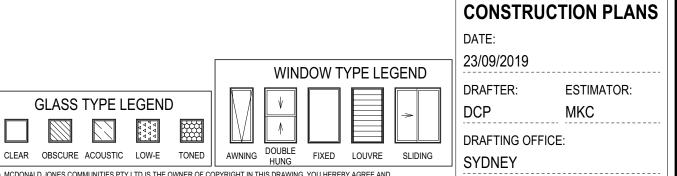

ALL CUT/FILL BATTERS ARE 1:1 MAX GRADIEN 2020 MCDONALD JONES COMMUNITIES PTY LTD (ACN 603 418 364). THIS DRAWING IS AN ORIGINAL ARTISTIC WORK WITHIN THE MEANING OF THE COPYRIGHT ACT 1968 (CTH). MCDONALD JONES COMMUNITIES PTY LTD IS THE OWNER OF COPYRIGHT IN THIS DRAWING. YOU HEREBY AGREE AND UNDERTAKE THAT YOU WILL NOT IN ANY WAY REPRODUCE, COPY, MODIFY, USE OR TAKE ADVANTAGE OF THE DRAWING TO BUILD A HOUSE BASED ON THIS PLAN (WHETHER IN WHOLE OR IN PART) WITHOUT THE PRIOR WRITTEN CONSENT OF MCDONALD JONES COMMUNITIES PTY LTD.



	l		DRAWING	ı	DRAWN
	ı	3	FRAME AMENDED TO STEEL	DCP	2019.09.0
	ı	4	FACADE REVISED TO STOCKLAND GUIDELINES	DCP	2019.09.
	ı	5	CONSTRUCTION PLANS	DCP	2019.09.2
	ı	6	KORDON TERMITE TREATMENT NOTE ADDED	DCP	2019.09.2
	ı	7	ENS VANITY UPGRADED	JNO	2020.04.

	CLIENT:			LOT No.:
9.06	COMPLETE BY MCDONALD	JONES		3138
9.10	ADDRESS:			DP No.:
9.23	64 BARRALLIER DRIVE			1230911
9.26	SUBURB:	POSTCODE:	COUNCIL:	SECTION No.:
4.14	MARSDEN PARK	2765	BLACKTOWN CITY	N/A

HOUSE DESIGN:	HOUSE CODE:			
HEWITSON 29	H-CCHHWS10DA	11.		
FACADE DESIGN: FACADE CODE:				
BENTLEIGH F-CCHHWS10BTLYA				
SHEET TITLE:	SCALES: SHEET No.	16		
ELEVATIONS / SECTION	1:100 7 / 20	JL		

DO NOT SCALE DRAWINGS, USE FIGURED DIMENSIONS ONLY. CHECK AND VERIEY DIMENSIONS AND LEVELS PRIOR TO THE COMMENCEMENT OF AN WORK. ALL DISCREPANCIES TO BE REPORTED TO THE DRAFTING OFFICE



RIGHT ELEVATION Scale: 1:100

GLASS TYPE LEGEND

CLEAR OBSCURE ACOUSTIC LOW-E TONED

WINDOW TYPE LEGEND

WINDOW TYPE LEGEND

AWNING DOUBLE HUNG FIXED LOUVRE SLIDING

DATE:
23/09/2019

DRAFTER: ESTIMATOR:
DCP MKC

DRAFTING OFFICE:

**SYDNEY** 

**CONSTRUCTION PLANS** 

REFER TO SHEET 1 (COVER SHEET) FOR ALL

UILDING INFORMATION REGARDING:

SUSTAINABILITY REQUIREMENTS

SITE CLASSIFICATION
GENERAL BUILDING INFORMATION

FIRST FLOOR WINDOW OPENINGS TO BE RESTRICTED AS REQUIRED BY NCC D2.24 (VOLUME ONE) AND/OR NCC 3.9.2.5 (VOLUME

SH = SNAP HEADER SILL

AGGRESSIVE SOIL REQUIREMENTS

SEE SHEET 1 (COVER SHEET) FOR DETAILS

ALL CUT/FILL BATTERS ARE 1:1 MAX GRADIEN 2020 MCDONALD JONES COMMUNITIES PTY LTD (ACN 603 418 364). THIS DRAWING IS AN ORIGINAL ARTISTIC WORK WITHIN THE MEANING OF THE COPYRIGHT ACT 1968 (CTH). MCDONALD JONES COMMUNITIES PTY LTD IS THE OWNER OF COPYRIGHT IN THIS DRAWING. YOU HEREBY AGREE AND UNDERTAKE THAT YOU WILL NOT IN ANY WAY REPRODUCE, COPY, MODIFY, USE OR TAKE ADVANTAGE OF THE DRAWING TO BUILD A HOUSE BASED ON THIS PLAN (WHETHER IN WHOLE OR IN PART) WITHOUT THE PRIOR WRITTEN CONSENT OF MCDONALD JONES COMMUNITIES PTY LTD.



	l		DRAWING	ı	DRAWN
	ı	3	FRAME AMENDED TO STEEL	DCP	2019.09.0
	ı	4	FACADE REVISED TO STOCKLAND GUIDELINES	DCP	2019.09.
	ı	5	CONSTRUCTION PLANS	DCP	2019.09.2
	ı	6	KORDON TERMITE TREATMENT NOTE ADDED	DCP	2019.09.2
	ı	7	ENS VANITY UPGRADED	JNO	2020.04.

l	CLIENT:	LOT No.:		
9.06	COMPLETE BY MCDONALD	3138		
9.10	ADDRESS:	DP No.:		
9.23	64 BARRALLIER DRIVE			1230911
9.26	SUBURB:	POSTCODE:	COUNCIL:	SECTION No.:
)4.14	MARSDEN PARK	2765	BLACKTOWN CITY	N/A

HOUSE DESIGN:	HOUSE CODE:	
HEWITSON 29	H-CCHHWS10DA	
FACADE DESIGN:	FACADE CODE:	
BENTLEIGH	F-CCHHWS10BTLYA	
SHEET TITLE:	SCALES:	SHEET No.:
ELEVATIONS	1:100	8 / 20

DO NOT SCALE DRAWINGS, USE FIGURED DIMENSIONS ONLY. CHECK AND VERIPY DIMENSIONS AND LEVELS PRIOR TO THE COMMENCEMENT OF ANY WORK. ALL DISCREPANCIES TO BE REPORTED TO THE DRAFTING OFFICE.

951412

File Loca